



0007924100 28 Jul 2022

Assessor Shafee Hassan
Accreditation No. DMV19/1938
Address
Lot A, 21 EDGAR STREET,
YAGOONA, NSW, 2199



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LEGEND

	200MM DINTEL WALL
	250MM BRICK VENEER CONSTRUCTION
	270MM DOUBLE BRICK CONSTRUCTION
	110MM SINGLE BRICK CONSTRUCTION
	110MM STUD WALL
	200MM BLOCK WALL CONSTRUCTION


EX XXXX EXISTING NATURAL GROUND LEVELS

30 SET DOWN IN BATHROOMS

XXXX SSL - STRUCTURAL SLAB LEVEL

EXISTING STRUCTURES TO BE DEMOLISHED.

GENERAL NOTES:
1. Written dimensions to take precedence over scale.
2. Builder to verify all boundary clearances and site set out dimensions prior to commencement of construction.
3. Levels and contours are based on supplied datum, prior to construction the relevant authority should be contacted for possible minimum floor level requirements and flood information.
4. All works to be carried out in accordance with the Building Code of Australia, all Local and State Government Ordinances, relevant Australian Standards, Local Electricity and Water Authorities concerned.
5. All structural work and site drainage to be subject to the Engineers details or certification where required by Council.
6. Articulation joints in masonry to be provided as per Engineers Details and/or in accordance with BCA clause 3.3.1.8.
7. Retaining walls are required to be engineer designed and certified where required.
8. All plumbing works to be strictly in accordance with A.S. 3500 and approved by relevant authorities.
9. All drawings are to be read in conjunction with the Engineer's Structural Drawings.
10. All windows and glazing to comply with A.S. 1288 & A.S. 2047.
11. Batters to comply with appropriate soil classification described in Table 3.1.1.1 BCA Vol 2.
12. Engineer to provide design to address footings if built in close proximity to sewer, stormwater easements.
13. Vehicular crossover to be constructed as per Council requirements.
14. Articulated joints in accordance with BCA 3.3.1.5 (Vol2)
15. Ventilation to be to an exhaust fan in accordance with BCA-14.5 & As-1668.2
16. Provide cold water connection & gpo to dishwasher space
17. Hotwater system to comply with A.S.3500
18. Downpipes to be a maximum 12m spacing and adjacent to valley intersections
19. Drainage to be in accordance with part 3 of the BCA, point of discharge to meet local authority requirement

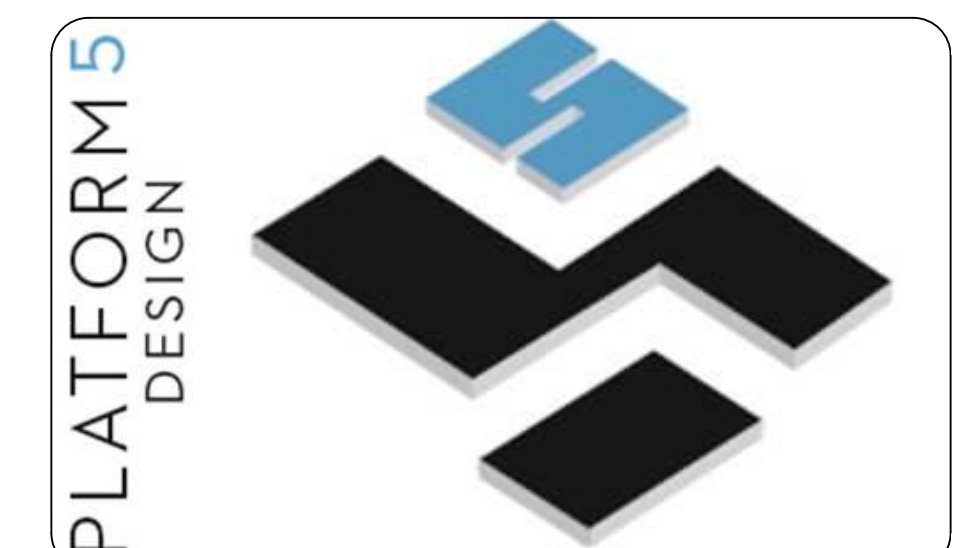

16 RAILWAY PARADE, BURWOOD, NSW, SYDNEY - 2134-
EMAIL: INFO@PLATFORMFIVE.COM.AU
WEBSITE: WWW.PLATFORMFIVE.COM.AU

PROJECT TITLE

21 EDGAR STREET, YAGOONA - NSW - 2199

CLIENT

VISCONA DEVELOPMENT GROUP PTY LTD

REV	DESCRIPTION	DATE
A	ISSUE FOR INFORMATION	14/06/2022
B	ISSUE FOR CONSULTANTS	15/06/2022
C	ISSUE FOR DA SUBMISSION	30/07/2022

DRAWING TITLE:
SITE LOCATION & ANALYSIS

PROJECT NUMBER:
22-025

DRAWING NUMBER: **DA1001**


DATE OF ISSUE: **30/07/2022**

C

N

SCALE: **AS SHOWN**

DEVELOPMENT APPLICATION

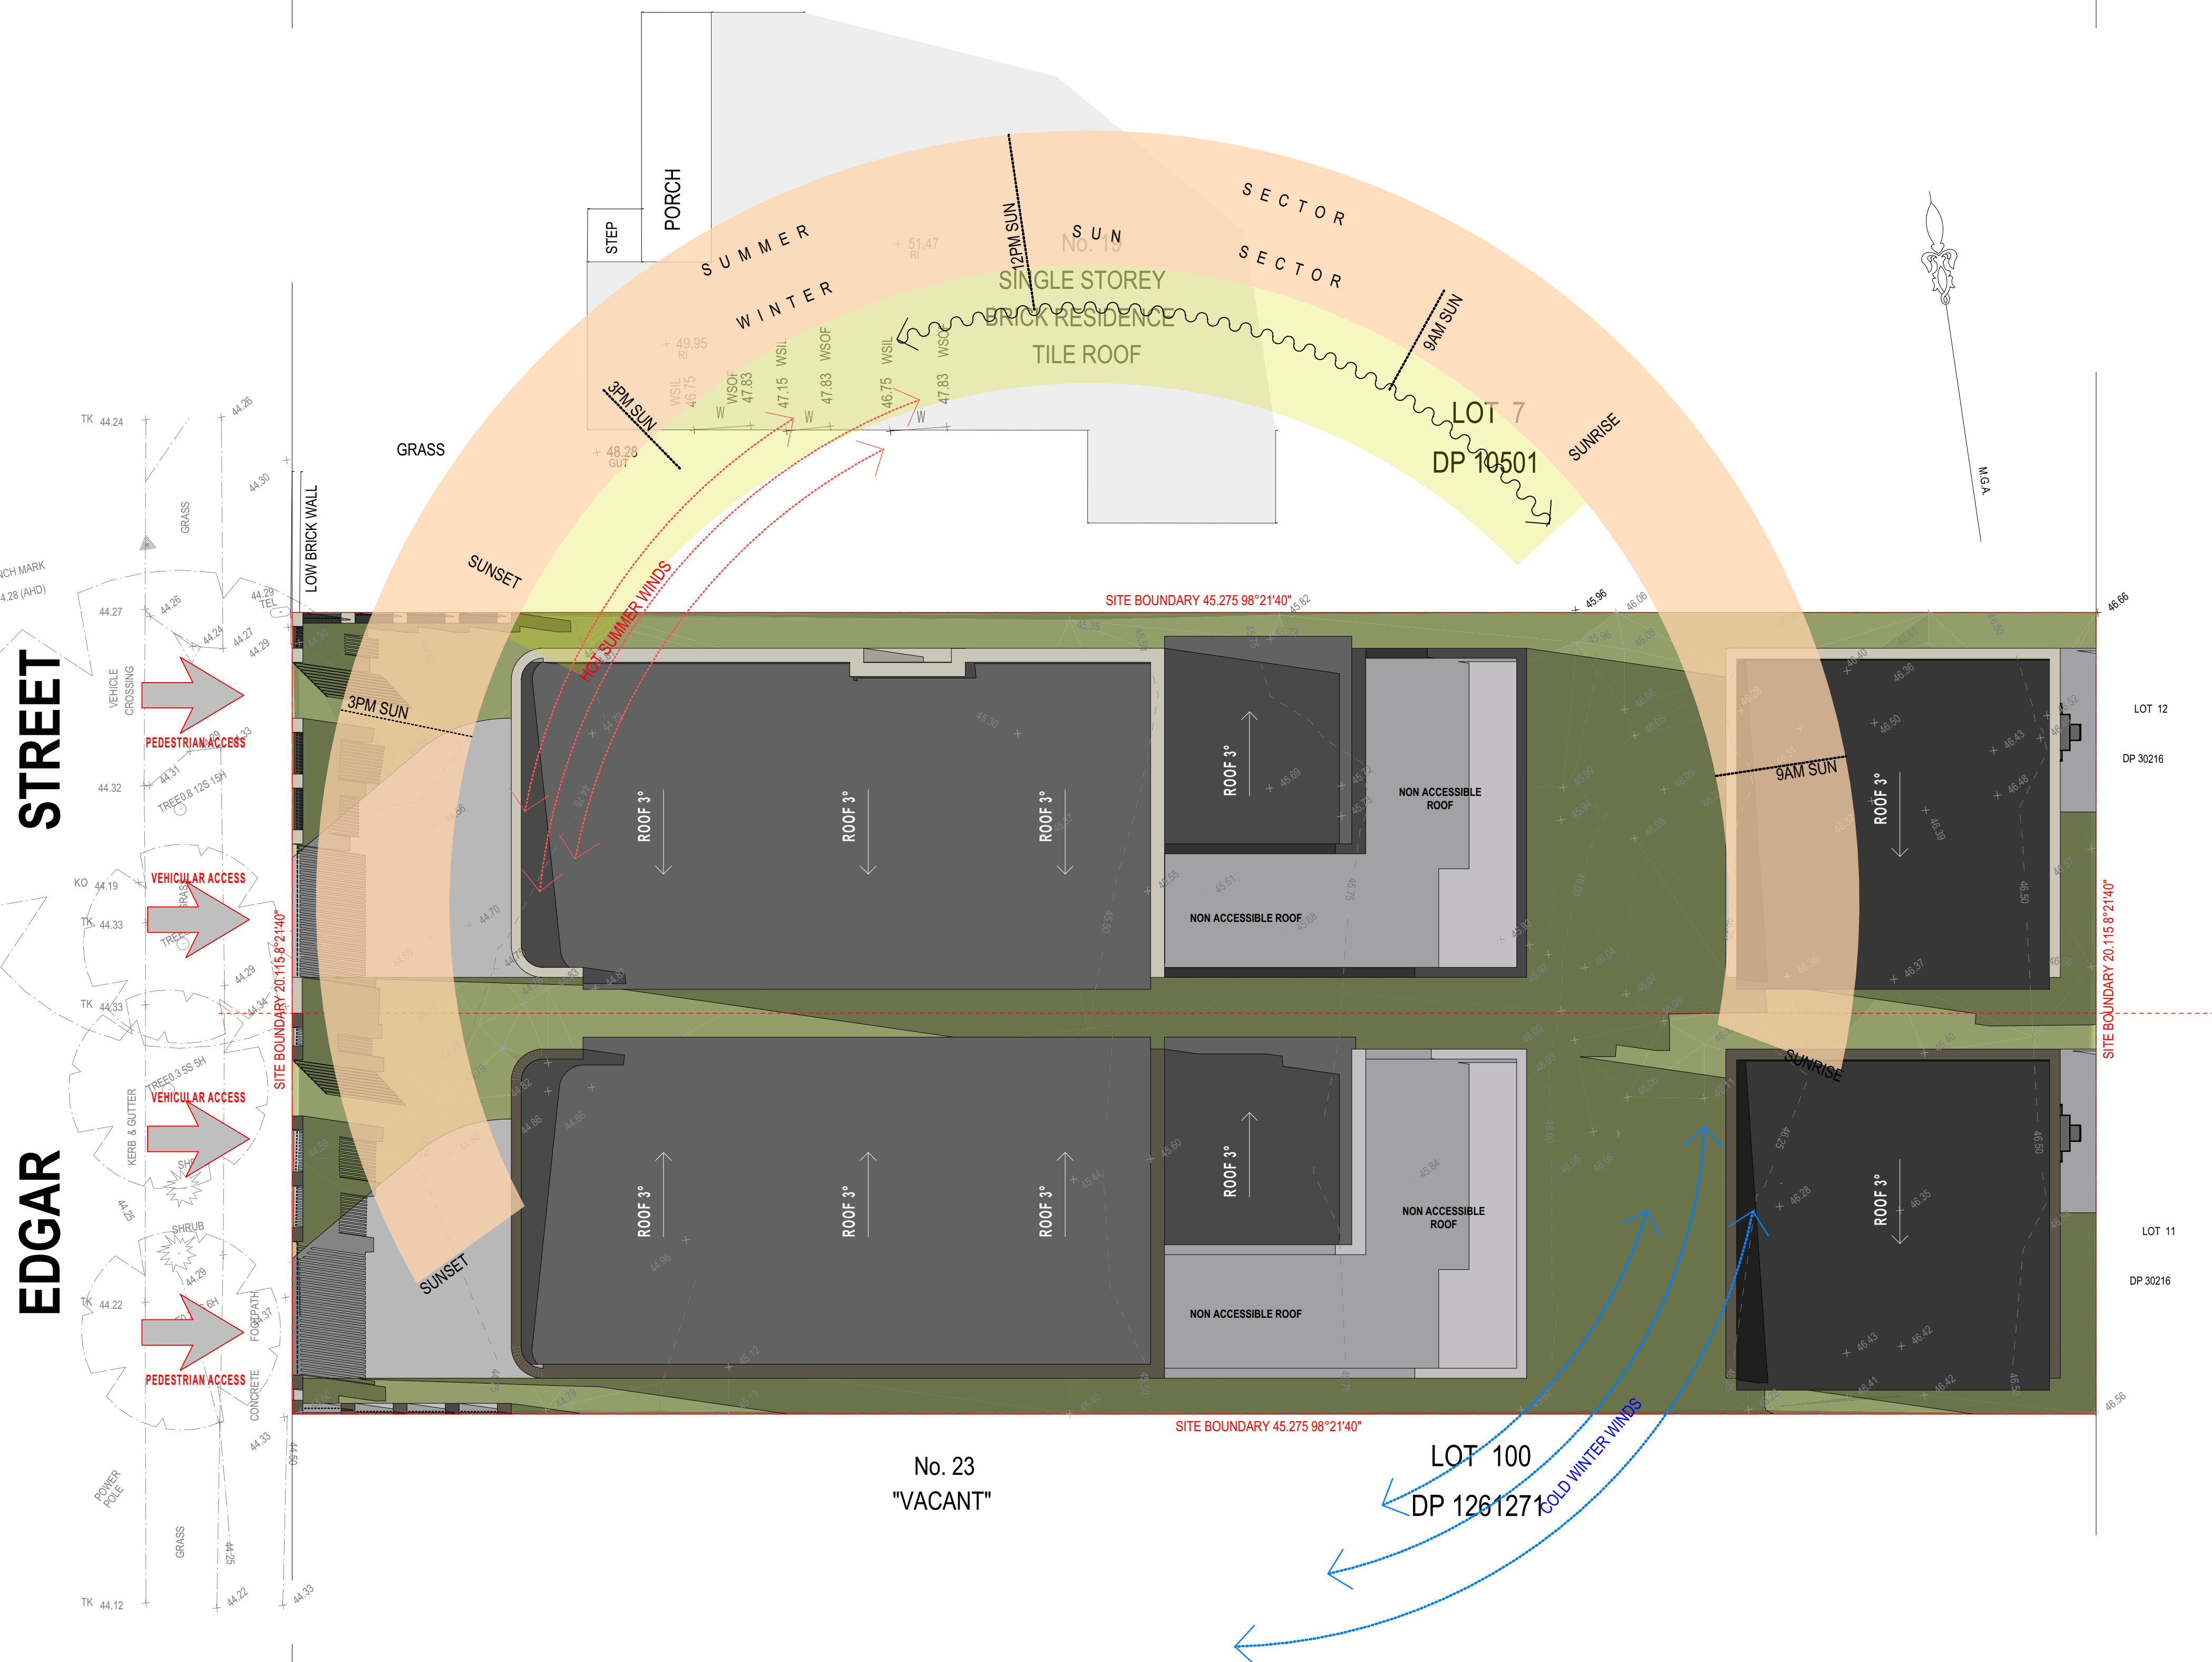

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30 SET DOWN IN BATHROOMS


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PLATFORM 5
DESIGN



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PROJECT TITLE

21 EDGAR STREET, YAGOONA - NSW - 2199

CLIENT

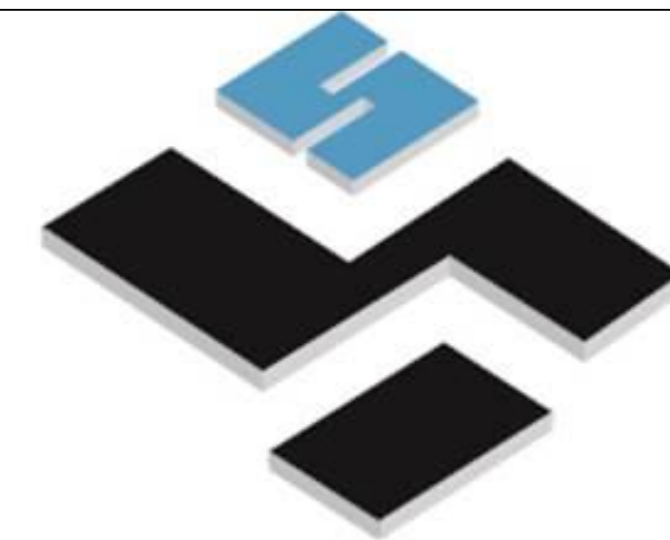VISCONA DEVELOPMENT GROUP PTY LTD

REV	DESCRIPTION	DATE
A	ISSUE FOR INFORMATION	14/06/2022
B	ISSUE FOR CONSULTANTS	15/06/2022
C	ISSUE FOR DA SUBMISSION	30/07/2022

DRAWING TITLE:

SITE PLAN

PROJECT NUMBER:

22-025

DRAWING NUMBER: **DA1002**

DATE OF ISSUE: **30/07/2022**

C

N

SCALE: **AS SHOWN**

DEVELOPMENT APPLICATION

SITE PLAN

SCALE 1:100

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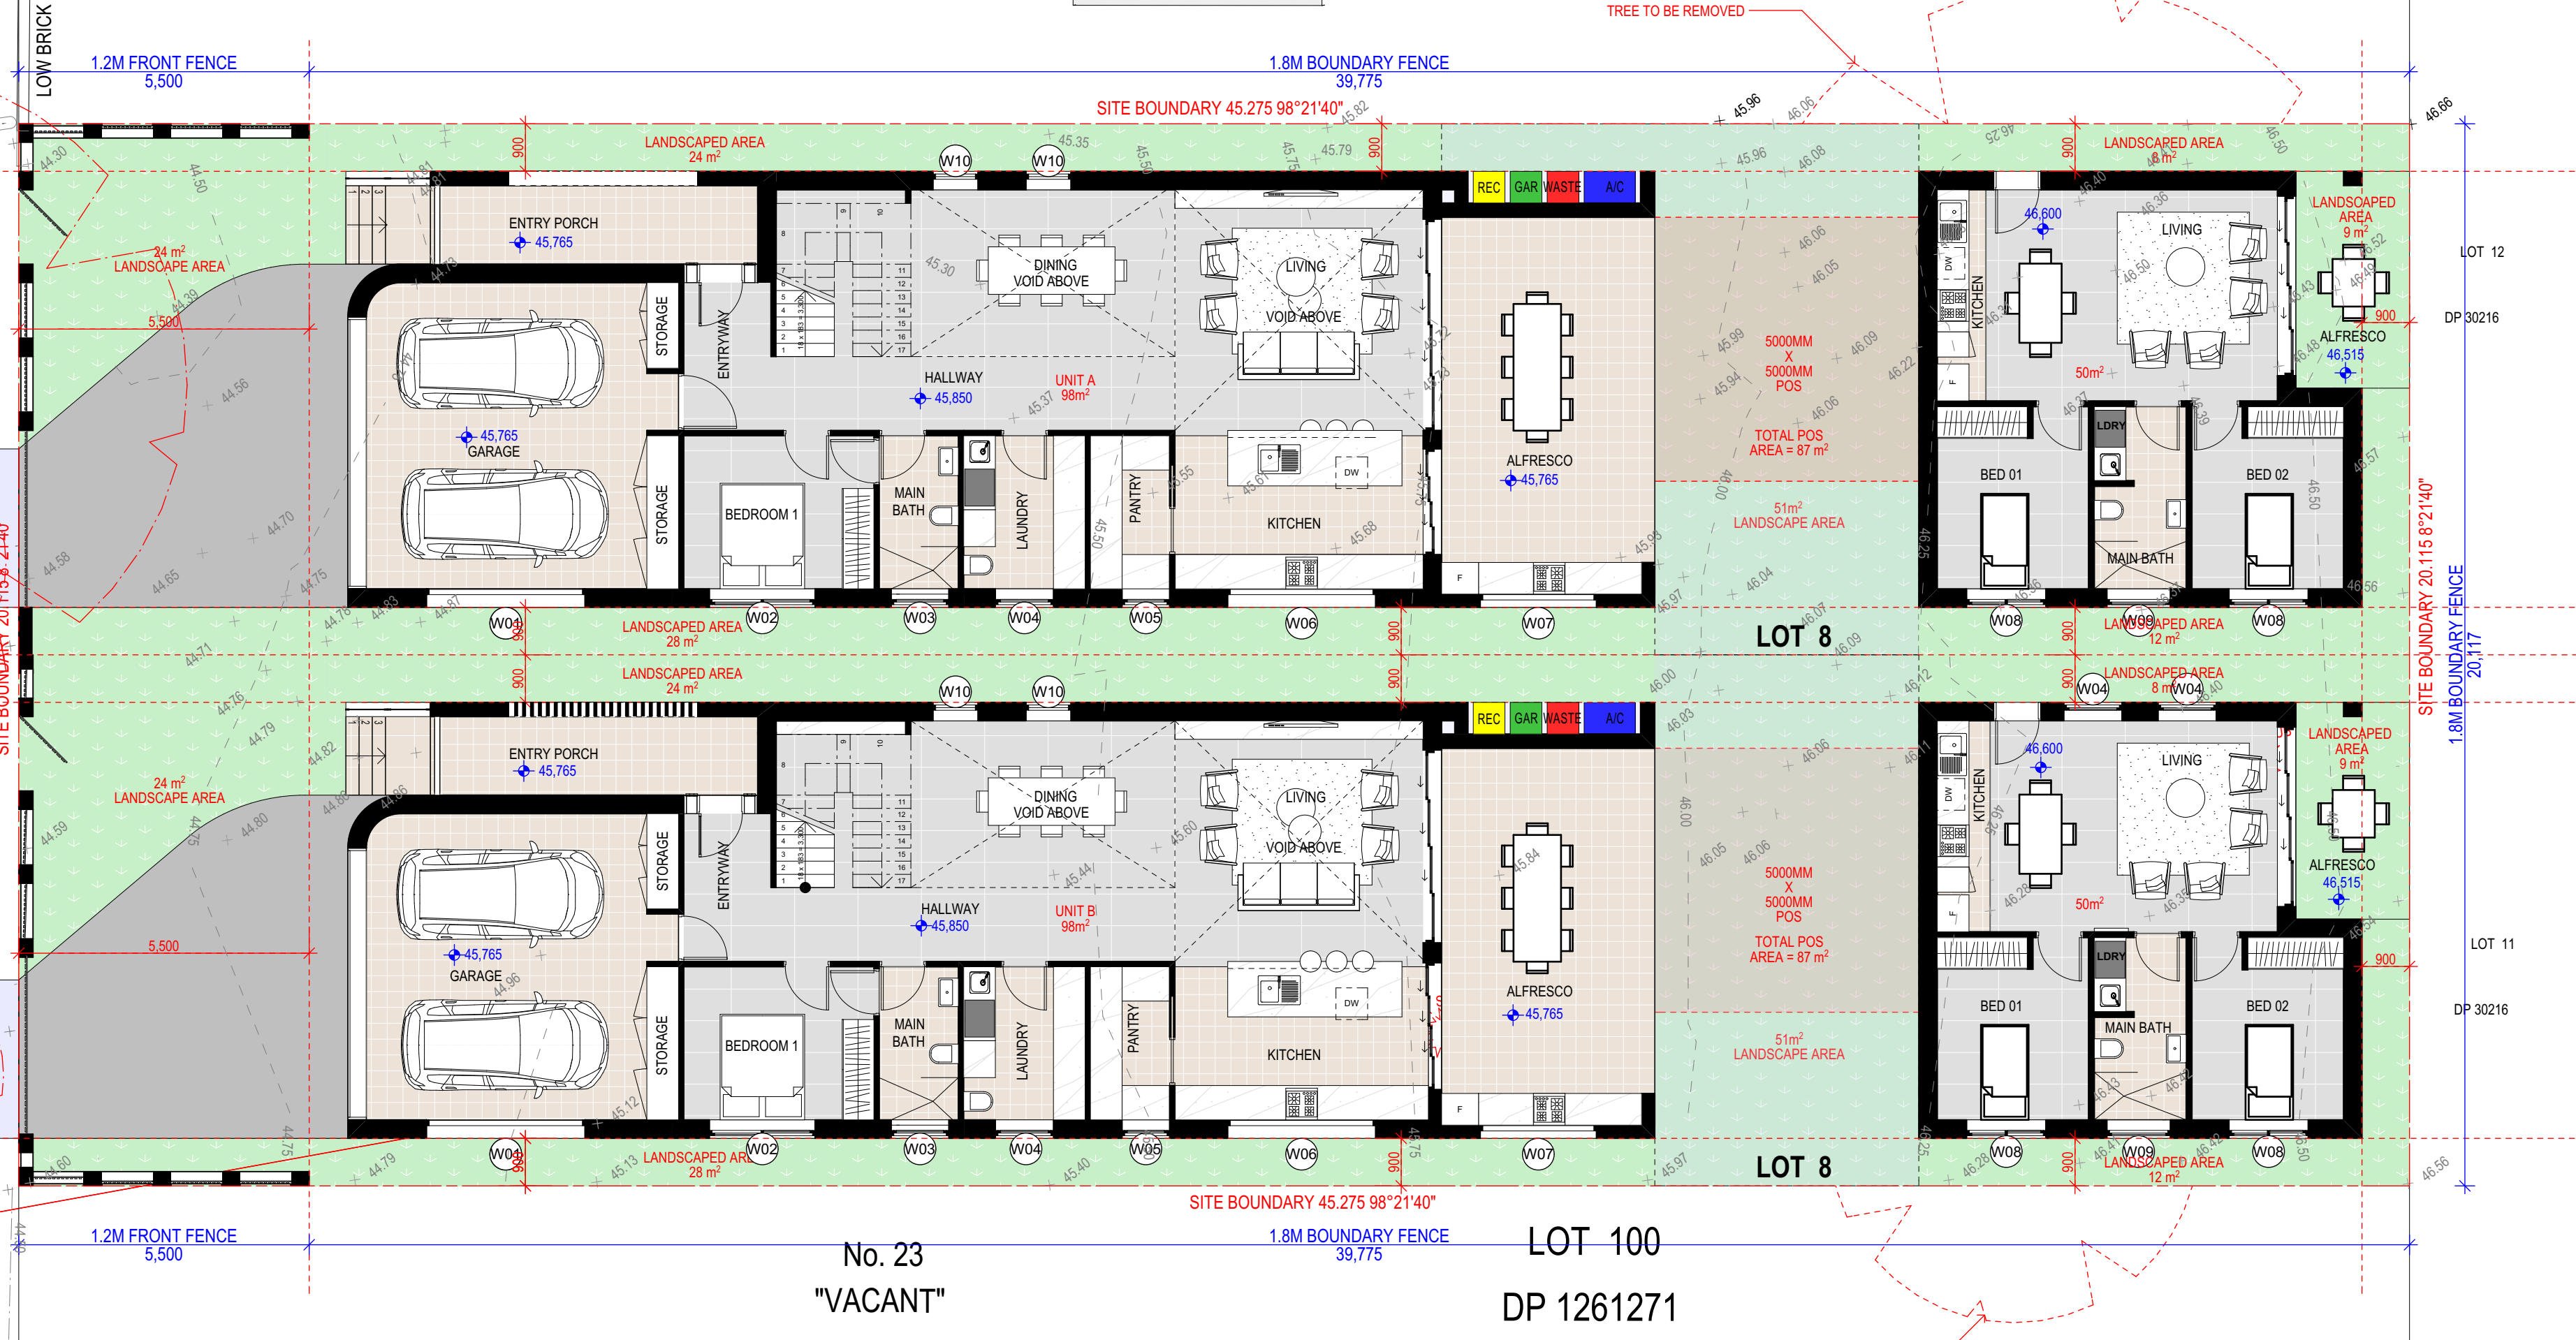
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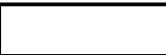



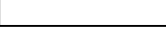

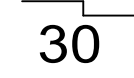
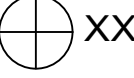
LOT 7
DP 10501



No. 23
"VACANT"

LOT 100
DP 1261271

LEGEND

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	110MM STUD WALL
	200MM BLOCK WALL CONSTRUCTION
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15. Ventilation to we to be an exhaust fan in accordance with BCA-4.5 & As-1668.2
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PLATFORM 5
DESIGN



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PROJECT TITLE

21 EDGAR STREET, YAGOONA - NSW - 2199

CLIENT

VISCONA DEVELOPMENT GROUP PTY LTD

REV	DESCRIPTION	DATE
A	ISSUE FOR INFORMATION	14/06/2022
B	ISSUE FOR CONSULTANTS	15/06/2022
C	ISSUE FOR DA SUBMISSION	30/07/2022

DRAWING TITLE:
DETAILED CALCULATIONS

PROJECT NUMBER:
22-025

DRAWING NUMBER: **DA1003**

DATE OF ISSUE
30/07/2022

C

N

SCALE: **AS SHOWN**

DEVELOPMENT APPLICATION

DETAILED CALCULATION SCHEDULE - UNIT A			
SITE AREA	910.8m² BY DP CALCULATION)		
SITE CALCULATIONS	REQUIREMENT	PROPOSED	COMPLIES
LOT SIZE	MIN 450.00m²	MIN 910.8m²	YES
FRONTAGE	N/A	20.115m	YES
BANKSTOWN DCP 2015	REQUIREMENT	PROPOSED	COMPLIES
FLOOR SPACE RATIO	= 0.5:1 or 455.4m²	227 m²	YES
(Measured to the internal side of external wall)	Each Unit = 227.7m²	GF = 98 m²	
		L1 = 79 m²	
	Secondary Dwelling = 60m²	= 50 m²	YES
MAXIMUM H.O.B	MAX . 9m	< 9m	YES
SETBACKS			
FRONT SETBACK			
GROUND	5500 mm	5500mm	YES
LEVEL ONE	6500mm	6500mm	YES
SIDE SETBACKS			
GROUND	900mm	900mm	YES
LEVEL ONE	1500mm	1500mm	YES
REAR SETBACK	N/A	N/A	N/A
LANDSCAPING	45% or 49.95m² of area between front setback dwelling	65 m²	YES
CUT AND FILL	REFER TO SECTIONS	< 1000mm	YES

DETAILED CALCULATION SCHEDULE - UNIT B			
SITE AREA	910.8m² BY DP CALCULATION)		
SITE CALCULATIONS	REQUIREMENT	PROPOSED	COMPLIES
LOT SIZE	MIN 450.00m²	MIN 910.8m²	YES
FRONTAGE	N/A	20.115m	YES
BANKSTOWN DCP 2015	REQUIREMENT	PROPOSED	COMPLIES
FLOOR SPACE RATIO	= 0.5:1 or 455.4m²	227 m²	YES
(Measured to the internal side of external wall)	Each Unit = 227.7m²	GF = 98 m²	
		L1 = 79 m²	
	Secondary Dwelling = 60m²	= 50 m²	YES
MAXIMUM H.O.B	MAX . 9m	< 9m	YES
SETBACKS			
FRONT SETBACK			
GROUND	5500 mm	5500mm	YES
LEVEL ONE	6500mm	6500mm	YES
SIDE SETBACKS			
GROUND	900mm	900mm	YES
LEVEL ONE	1500mm	1500mm	YES
REAR SETBACK	N/A	N/A	N/A
LANDSCAPING	45% or 49.95m² of area between front setback dwelling	65 m²	YES
CUT AND FILL	REFER TO SECTIONS	< 1000mm	YES

Thermal Specification				
Issued in accordance with BASIX Thermal Comfort Simulation Method.				
Assessor No #	DMN/19/1938	Projects:	YAGOONA	
Thermal performance specifications				
Following specification must apply to all instances of that element for the whole project. If different construction elements are applied then the Assessor Certificate is no longer valid.				
Certificate No:	21 EDGAR STREET (LOT-A)			
	Unit-A1(Primary)	Unit-A2(Granny)		
External walls Construction	Added Insulation			
Brick Veneer	R2.5	R2.5		
Brick Veneer(Garage)	R2.5	-		
Internal walls Construction				
Plasterboard on studs (Garage)	R2.5	-		
Plasterboard on studs	Nil	Nil		
Roof Construction				
Metal Roof	Foil+Bulk(R1.3 Anticon)	Foil+Bulk(R1.3 Anticon)		
Colour	Medium	Medium		
Ceilings Construction				
Plaster board	R3.0	R3.0		
Floors Construction	Covering			
Concrete (Slab on ground)	Default	Nil	Nil	
Timber(Floor between)	Default	Nil	Nil	
Timber(Above garage)	Default	R3.0	Nil	
Windows				
All window and glazed door to be selected as per AFRC. Deviation is accepted ±5% . This tolerance ONLY applies to SHGC, the U-value can always be lower but not higher than the values stated.				
Area(M ²)	Frame	Ext. cover	U Val	SHGC
Unit-1A	Alum/Sliding	As drawn	4.6	0.47
	Alum/Awning	As drawn	4.8	0.42
	Alum/Fixed	As drawn	4.4	0.48
	Alum/Sliding dr	As drawn	4.4	0.46
	Alum/Fixed	As drawn	3.1	0.27
W15 & W16	Alum/Fixed	As drawn	3.1	0.27
Unit-1B	Alum/Sliding(GP-B)	As drawn	6.7	0.70
	Alum/Awning(Gp-A)	As drawn	6.7	0.57
Skylights				
Area (M ²)	Type	Glazing		
Nil	Nil	Nil		
Fixed shading (eaves, pergolas, verandas , awnings)				
All shade elements modelled as drawn				
Weather seals to windows and doors			Be provided	
All down lights be sealed			Yes	

BASIX Commitments
Basix Certificate No:

FOR UNIT-A1 (Primary) & A2Granny)

HOT WATER
•Gas Instantaneous -5.5 star

VENTILATION
•Bathrooms: Individual fan ducted to façade or roof with interlock to light switch
•Kitchen: individual fan, not ducted with manual ON /OFF
•Laundry:Individual fan ducted to façade or roof with manual ON /OFF

AIR CON:
•Cooling & Heating : 1- Phase Air con-EER 2.5-3.0 (Zoned)

LIGHTING
•Energy efficient light fittings (LED or fluorescent for each individual spaces)

KITCHEN
•Gas cooktop & electric oven

CLOTHES DRYING LINE
• No, In door Clothes drying line
• Yes, outdoor clothing drying line

VENTILATED SPACE
No, Ventilated refrigerated space

WATER SAVING
•4 star shower heads
•4 star toilets or better
•5 star kitchen tap
•5 Star bathroom tap

RAIN WATER&STORM WATER TANK:
•1500 L rain water tank used for landscape & Laundry(Unit-A2)
•1500 L rain water tank used for landscape.(Unit-A1)



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Issued in accordance with BASIX Thermal Comfort Simulation Method.						
Assessor No #	DMN/19/1938		Projects:		YAGOONA	
Thermal performance specifications						
Following specification must apply to all instances of that element for the whole project. If different construction elements are applied then the Assessor Certificate is no longer valid.						
Certificate No: 21 EDGAR STREET(LOT-B)						
			Unit-B1(Primary)		Unit-B2(Granny)	
External walls Construction			Added Insulation			
Brick Veneer			R2.5		R2.5	
Brick Veneer(Garage)			R2.5		-	
Internal walls Construction						
Plasterboard on studs (Garage)			R2.5		-	
Plasterboard on studs			Nil		Nil	
Roof Construction						
Metal Roof			Foil+Bulk(R1.3 Anticon)		Foil+Bulk(R1.3 Anticon)	
Colour			Medium		Medium	
Ceilings Construction						
Plaster board			R3.0		R3.0	
Floors Construction			Covering			
Concrete (Slab on ground)			Default		Nil	
Timber(Floor between)			Default		Nil	
Timber(Above garage)			Default		Nil	
Windows						
All window and glazed door to be selected as per AFRC. Deviation is accepted ±5% . This tolerance ONLY applies to SHGC, the U-value can always be lower but not higher than the values stated.						
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	Alum/Awning	As drawn	4.8	0.42	Single LowE Ntrl	
	Alum/Fixed	As drawn	4.4	0.48	Single LowE Ntrl	
	Alum/Sliding dr	As drawn	4.4	0.46	Single LowE Ntrl	
W15 & W16	Alum/Fixed	As drawn	3.1	0.27	Dbl Low E Ntrl	
Unit-1B	Alum/Sliding(Gp-B)	As drawn	6.7	0.70	Single Clear	
	Alum/Awning(Gp-A)	As drawn	6.7	0.57	Single Clear	
Skylights						
Area (M ²)	Type	Glazing				
Nil	Nil	Nil				
Fixed shading (eaves, pergolas, verandas , awnings)						
All shade elements modelled as drawn						
Weather seals to windows and doors			Be provided			
All down lights be sealed			Yes			

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Basix Certificate No:

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•Energy efficient light fittings (LED or fluorescent for each individual spaces)

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• No, In door Clothes drying line
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No, Ventilated refrigerated space

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•4 star shower heads
•4 star toilets or better
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RAIN WATER&STORM WATER TANK:
•1500 L rain water tank used for landscape & Laundry(Unit-B2)
•1500 L rain water tank used for landscape.(Unit-B1)



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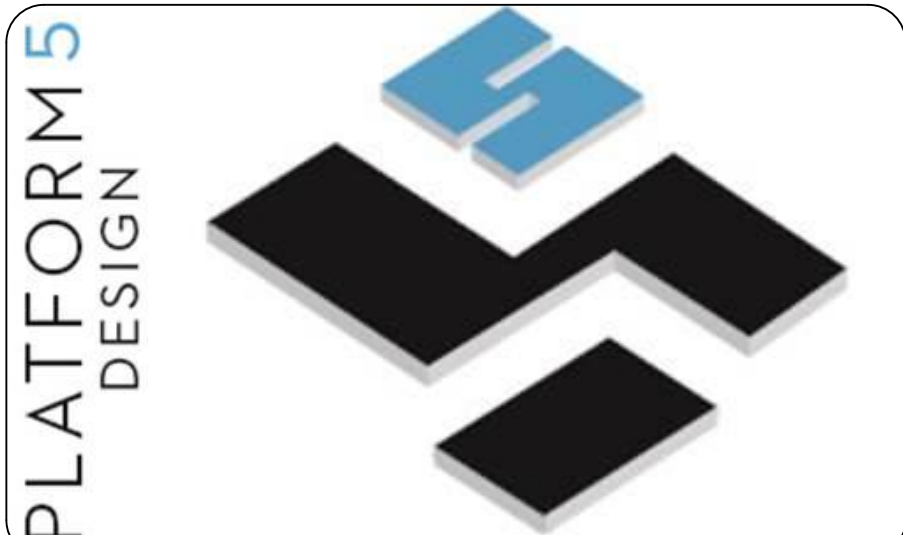
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B	ISSUE FOR CONSULTANTS	15/06/2022
C	ISSUE FOR DA SUBMISSION	30/07/2022

DRAWING TITLE: DEMOLITION PLAN	PROJECT NUMBER: 22-025
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DRAWING NUMBER: **DA1004**

DATE OF ISSUE **30/07/2022** **C** **N**

SCALE: **AS SHOWN**

DEVELOPMENT APPLICATION

DEMOLITION PLAN
SCALE 1:100


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7. Retaining walls are required to be engineer designed and certified where required.
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9. All drawings are to be read in conjunction with the Engineer's Structural Drawings.
10. All windows and glazing to comply with A.S. 1288 & A.S. 2047.
11. Batters to comply with appropriate soil classification described in Table 3.1.1.1 BCA Vol 2
12. Engineer to provide design to address loadings if built in close proximity to sewer, stormwater easements.
13. Vehicular crossover to be constructed as per Council requirements.
14. Articulated joints in accordance with BCA 3.3.1.8 (Vol2)
15. Ventilation to be to be an exhaust fan in accordance with BCA-14.5 & As-1668.2
16. Provide cold water connection & gpo to dishwasher space
17. Hotwater system to comply with A.S.3500
18. Downpipes to be a maximum 12m spacing and adjacent to valley intersections
19. Drainage to be in accordance with part 3 of the BCA, point of discharge to meet local authority requirement



16 RAILWAY PARADE, BURWOOD, NSW, SYDNEY - 2134-

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PROJECT TITLE

21 EDGAR STREET, YAGOONA - NSW - 2199

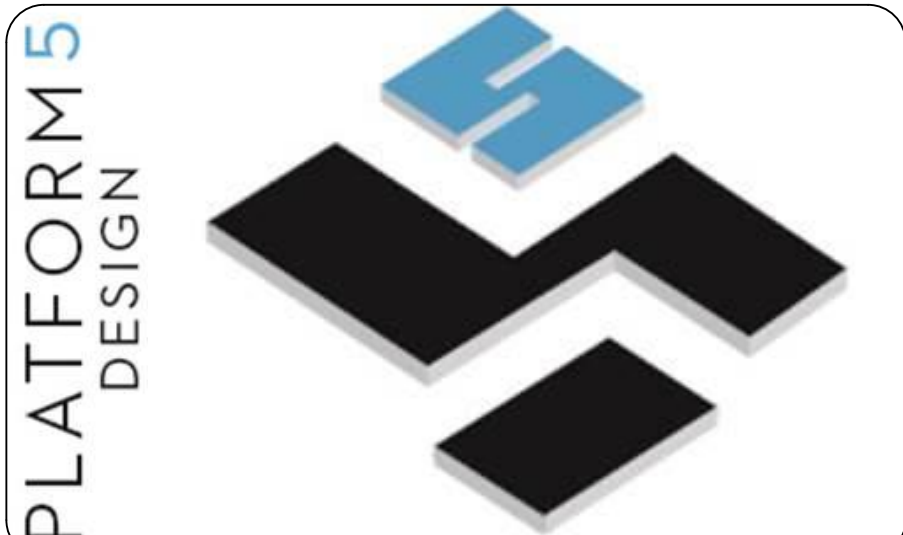CLIENT

VISCONA DEVELOPMENT GROUP PTY LTD

REV	DESCRIPTION	DATE
A	ISSUE FOR INFORMATION	14/06/2022
B	ISSUE FOR CONSULTANTS	15/06/2022
C	ISSUE FOR DA SUBMISSION	30/07/2022

DRAWING TITLE:
SUBDIVISION PLAN

PROJECT NUMBER:
22-025

DRAWING NUMBER: **DA1005**


DATE OF ISSUE: **30/07/2022**

C

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SCALE: **AS SHOWN**

DEVELOPMENT APPLICATION

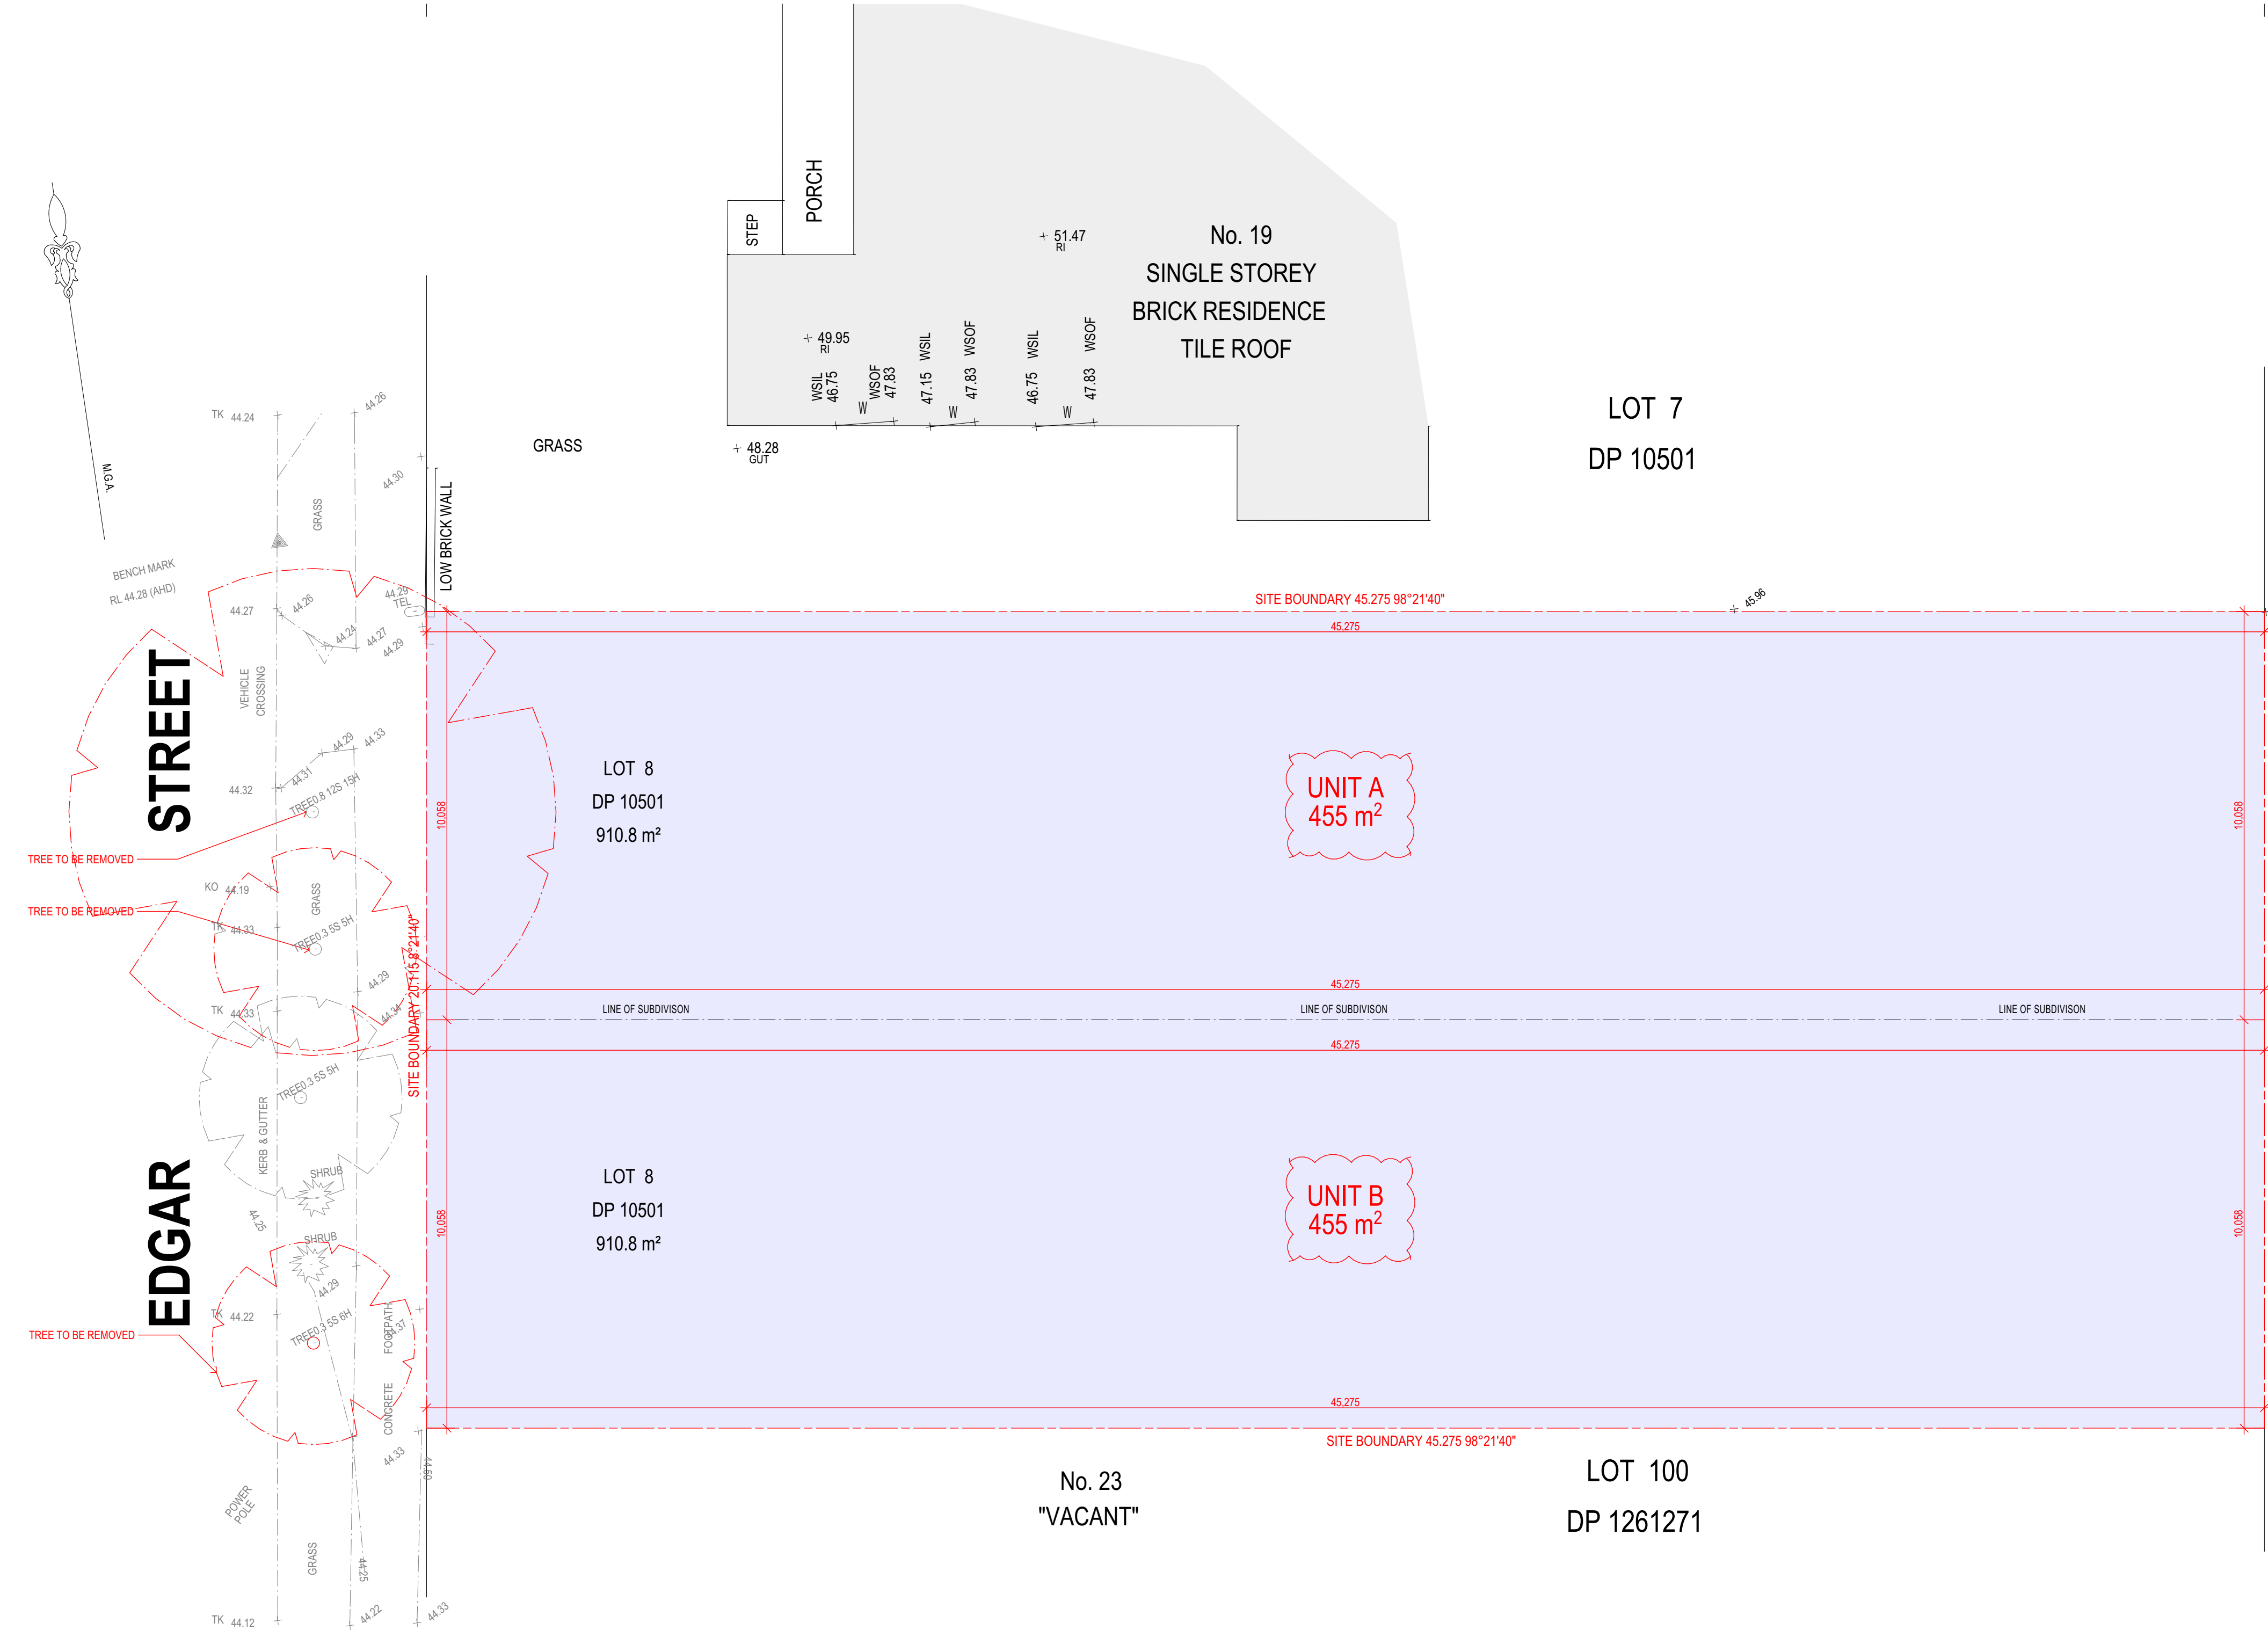

SUBDIVISION PLAN

1:100
SCALE 1:100



0007924100 28 Jul 2022

Assessor Shafee Hassan

Accreditation No. DMV19/1938

Address

Lot A , 21 EDGAR STREET ,
YAGOONA , NSW , 2199



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0007924090 28 Jul 2022

Assessor Shafee Hassan

Accreditation No. DMV19/1938

Address

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LEGEND

- 200MM DINCEL WALL
- 250MM BRICK VENEER CONSTRUCTION
- 270MM DOUBLE BRICK CONSTRUCTION
- 110MM SINGLE BRICK CONSTRUCTION
- 110MM STUD WALL
- 200MM BLOCK WALL CONSTRUCTION

EX XXXX EXISTING NATURAL GROUND LEVELS


30 SET DOWN IN BATHROOMS

XXXX SSL - STRUCTURAL SLAB LEVEL

EXISTING STRUCTURES TO BE DEMOLISHED.

- GENERAL NOTES:
- Written dimensions to take precedence over scale.
 - Builder to verify all boundary clearances and site set out dimensions prior to commencement of construction.
 - Levels and contours are based on supplied datum, prior to construction the relevant authority should be contacted for possible minimum floor level requirements and flood information.
 - All works to be carried out in accordance with the Building Code of Australia, all Local and State Government Ordinances, relevant Australian Standards, Local Electricity and Water Authorities concerned.
 - All structural work and site drainage to be subject to the Engineers details or certification where required by Council.
 - Articulation joints in masonry to be provided as per Engineers Details and/or in accordance with BCA clause 3.1.1.8.
 - Retaining walls are required to be engineer designed and certified where required.
 - All plumbing works to be strictly in accordance with A.S. 3500 and approved by relevant authorities.
 - All drawings are to be read in conjunction with the Engineer's Structural Drawings.
 - All windows and glazing to comply with A.S. 1288 & A.S. 2047.
 - Batters to comply with appropriate soil classification described in Table 3.1.1.1 BCA Vol 2
 - Engineer to provide design to address loadings if built in close proximity to sewer, stormwater easements.
 - Vehicular crossover to be constructed as per Council requirements.
 - Articulated ponds in accordance with BCA 3.3.1.5 (Vo2)
 - Ventilation to be in an exhaust fan in accordance with BCA-14.5 & As-1668.2
 - Provide cold water connection & go to dishwasher space
 - Hotwater system to comply with A.S.3500
 - Downpipes to be a maximum 12m spacing and adjacent to valley intersections
 - Drainage to be in accordance with part 3 of the BCA, point of discharge to meet local authority requirement

PLATFORM 5
DESIGN

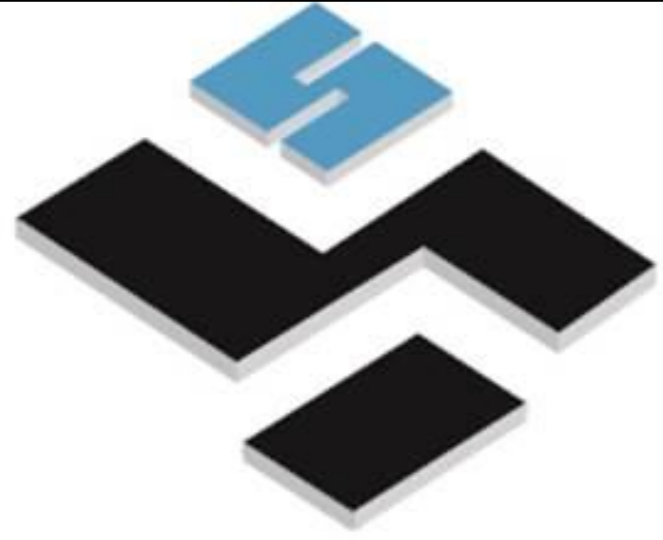

16 RAILWAY PARADE, BURWOOD, NSW, SYDNEY - 2134-

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WEBSITE: WWW.PLATFORMFIVE.COM.AU

PROJECT TITLE

21 EDGAR STREET, YAGOONA - NSW - 2199

CLIENT

VISCONA DEVELOPMENT GROUP PTY LTD

REV	DESCRIPTION	DATE
A	ISSUE FOR INFORMATION	14/06/2022
B	ISSUE FOR CONSULTANTS	15/06/2022
C	ISSUE FOR DA SUBMISSION	30/07/2022

DRAWING TITLE:
GROUND FLOOR PLAN

PROJECT NUMBER:
22-025

DRAWING NUMBER: **DA2002**

DATE OF ISSUE **30/07/2022**

C

N

SCALE: **AS SHOWN**

DEVELOPMENT APPLICATION



0007924100 28 Jul 2022

Assessor Shafee Hassan
Accreditation No. DMN/19/1938
Address
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0007924090 28 Jul 2022

Assessor Shafee Hassan
Accreditation No. DMN/19/1938
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No. 19
SINGLE STOREY
BRICK RESIDENCE
TILE ROOF

LOT 7
DP 10501

LOT 100
DP 1261271

DOOR SCHEDULE				
ID	Door Type	Width	Height	Quantity
D01	GARAGE DOOR	5,050	2,835	2
D02	HINGED DOOR	820	2,700	2
D03	HINGED DOOR	820	2,100	29
D04	HINGED DOOR	1,000	2,700	1
D05	POCKET DOOR	820	2,700	2
D06	HINGED DOOR	2,400	2,700	1
D07	HINGED DOOR	3,650	2,700	1
D08	HINGED DOOR	2,000	2,500	1
D09	HINGED DOOR	4,000	2,700	1
D10	SLIDING DOOR	3,400	2,500	2
D12	SLIDING DOOR	3,050	2,700	2

WINDOW SCHEDULE					
ID	WINDOW TYPE	WIDTH	HEIGHT	SILL HEIGHT	QUANTL.
W01	FIXED WINDOW	3,000	800	1,800	4
W02	SLIDING WINDOW	2,000	1,500	1,200	2
W03	AWNING WINDOW	1,090	1,800	900	2
W04	AWNING WINDOW	1,100	1,800	900	4
W05	AWNING WINDOW	900	1,800	900	2
W06	SLIDING WINDOW	2,800	670	930	2
W07	SLIDING WINDOW	2,200	670	930	2
W08	SLIDING WINDOW	1,500	900	1,800	4
W09	AWNING WINDOW	1,200	1,800	900	2
W10	AWNING WINDOW	850	2,100	600	4
W11	AWNING WINDOW	900	900	1,800	2

W12	AWNING WINDOW	1,000	1,700	1,000	2
W13	AWNING WINDOW	900	2,700	0	2
W14	AWNING WINDOW	1,100	900	1,800	2
W15	FIXED WINDOW	2,000	2,600	0	2
W16	FIXED WINDOW	2,610	2,600	0	2
W17	FIXED WINDOW	3,650	740	300	2
W18	FIXED WINDOW	4,000	740	300	2
W19	FIXED WINDOW	1,800	1,600	1,000	2
W20	SLIDING WINDOW	1,800	1,200	1,500	4
W21	SLIDING WINDOW	1,800	1,600	1,100	2
					52

GROUND FLOOR PLAN
SCALE 1:100



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LEGEND

	200MM DINCEL WALL
	250MM BRICK VENEER CONSTRUCTION
	270MM DOUBLE BRICK CONSTRUCTION
	110MM SINGLE BRICK CONSTRUCTION
	110MM STUD WALL
	200MM BLOCK WALL CONSTRUCTION

EX XXXX EXISTING NATURAL GROUND LEVELS

30 SET DOWN IN BATHROOMS


XXXX SSL - STRUCTURAL SLAB LEVEL

EXISTING STRUCTURES TO BE DEMOLISHED.

GENERAL NOTES:

- Written dimensions to take precedence over scale.
- Builder to verify all boundary clearances and site set out dimensions prior to commencement of construction.
- Levels and contours are based on supplied datum, prior to construction the relevant authority should be contacted for possible minimum floor level requirements and flood information.
- All works to be carried out in accordance with the Building Code of Australia, all Local and State Government Ordinances, relevant Australian Standards, Local Electricity and Water Authorities concerned.
- All structural work and site drainage to be subject to the Engineers details or certification where required by Council.
- Articulation joints in masonry to be provided as per Engineers Details and/or in accordance with BCA clause 3.3.1.8.
- Retaining walls are required to be engineer designed and certified where required.
- All plumbing works to be strictly in accordance with A.S. 3500 and approved by relevant authorities.
- All drawings are to be read in conjunction with the Engineer's Structural Drawings.
- All windows and glazing to comply with A.S. 1288 & A.S. 2047.
- Batters to comply with appropriate soil classification described in Table 3.1.1.1 BCA Vol 2
- Engineer to provide design to address loadings if built in close proximity to sewer, stormwater easements.
- Vehicular crossover to be constructed as per Council requirements.
- Articulated pits in accordance with BCA 3.3.1.8 (Vo2)
- Ventilation to be in an exhaust fan in accordance with BCA-14.5 & As-1668.2
- Provide cold water connection & go to dishwasher space
- Hotwater system to comply with A.S.3500
- Downpipes to be a maximum 12m spacing and adjacent to valley intersections
- Drainage to be in accordance with part 3 of the BCA, point of discharge to meet local authority requirement

PLATFORM 5
DESIGN

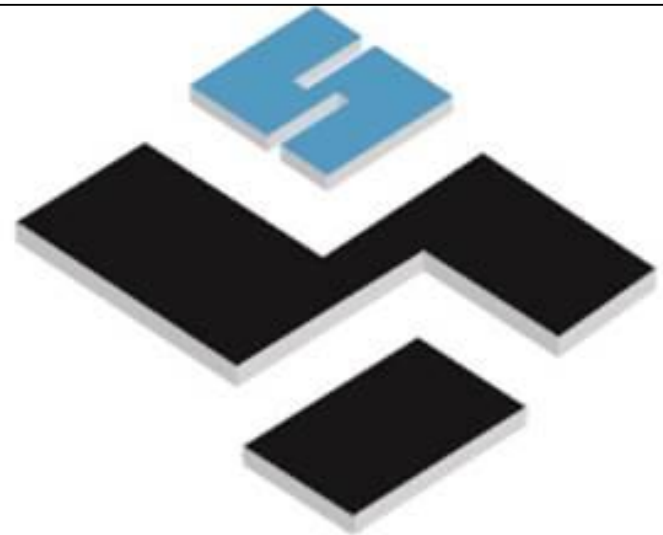

16 RAILWAY PARADE, BURWOOD, NSW, SYDNEY - 2134-

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PROJECT TITLE

21 EDGAR STREET, YAGOONA - NSW - 2199

CLIENT

VISCONA DEVELOPMENT GROUP PTY LTD

REV	DESCRIPTION	DATE
A	ISSUE FOR INFORMATION	14/06/2022
B	ISSUE FOR CONSULTANTS	15/06/2022
C	ISSUE FOR DA SUBMISSION	30/07/2022

DRAWING TITLE:

LEVEL 01

PROJECT NUMBER:

22-025

DRAWING NUMBER: **DA2003**

DATE OF ISSUE **30/07/2022**

C

N

SCALE: **AS SHOWN**

DEVELOPMENT APPLICATION



0007924100 28 Jul 2022

Assessor Shafee Hassan
Accreditation No. DMN/19/1938
Address
Lot A , 21 EDGAR STREET ,
YAGOONA , NSW , 2199



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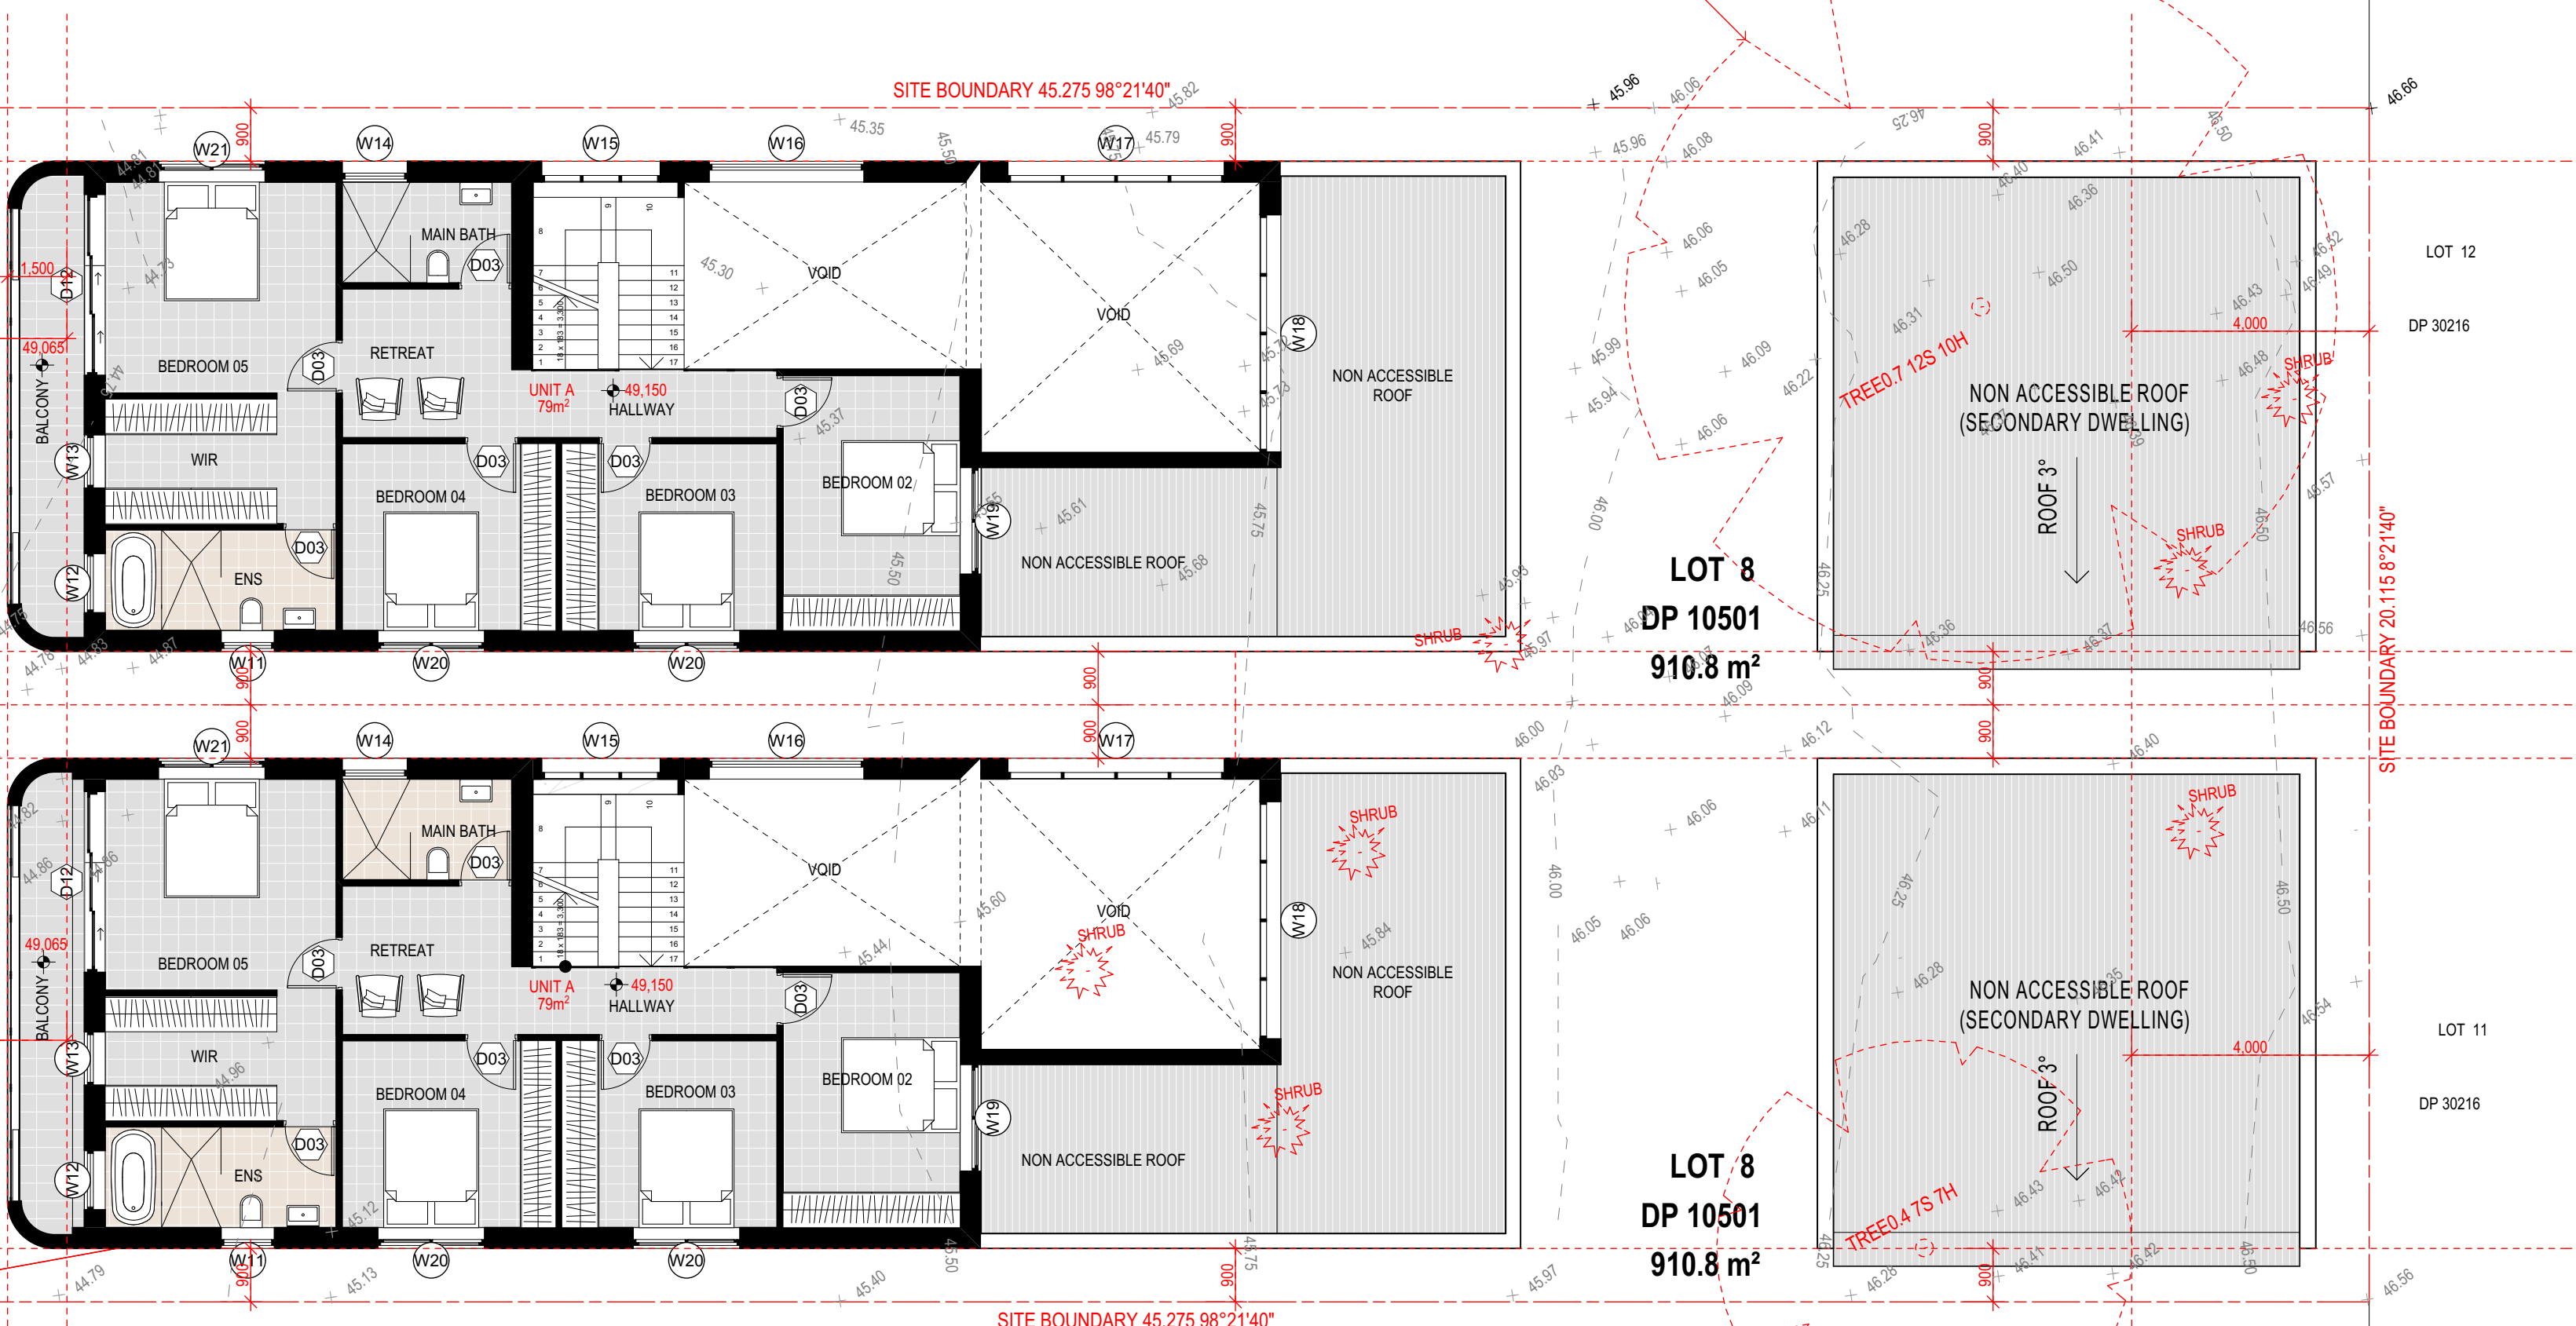
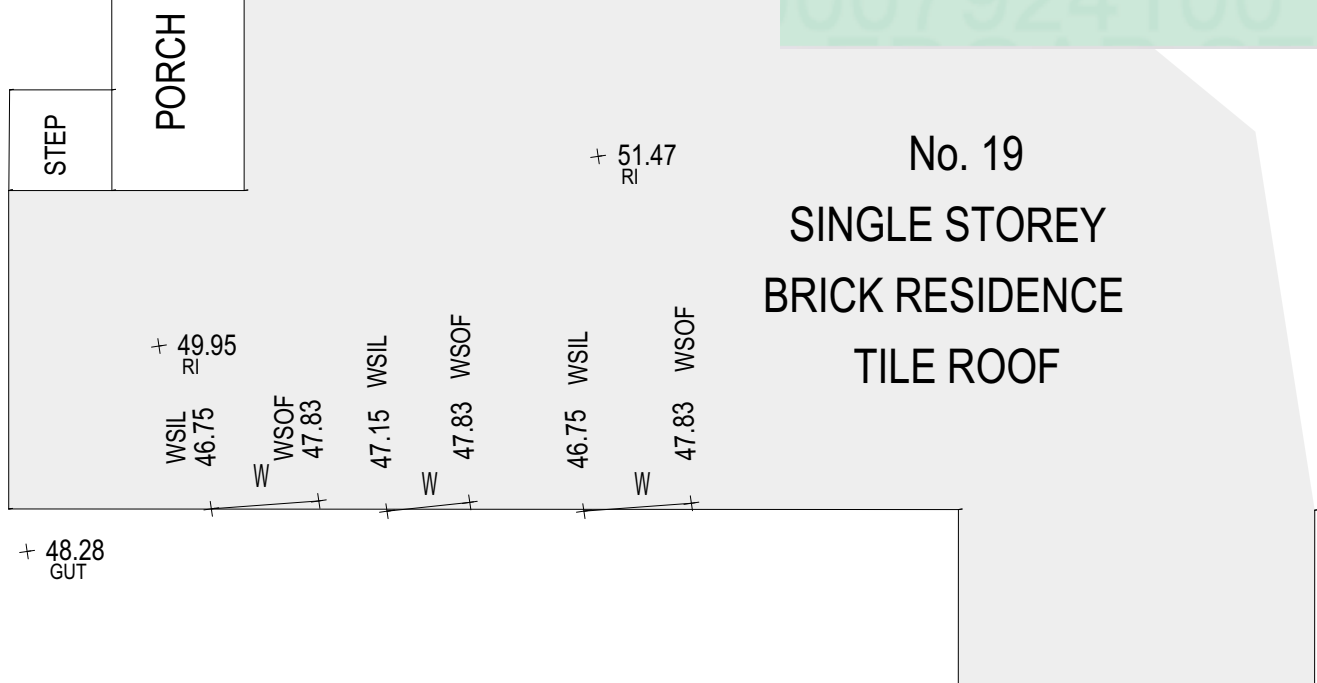


0007924090 28 Jul 2022

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Address
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YAGOONA , NSW , 2199



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No. 23
"VACANT"

LOT 100
DP 1261271

DOOR SCHEDULE				
ID	Door Type	Width	Height	Quantity
D01	GARAGE DOOR	5,050	2,835	2
D02	HINGED DOOR	820	2,700	2
D03	HINGED DOOR	820	2,100	29
D04	HINGED DOOR	1,000	2,700	1
D05	POCKET DOOR	820	2,700	2
D06	HINGED DOOR	2,400	2,700	1
D07	HINGED DOOR	3,650	2,700	1
D08	HINGED DOOR	2,000	2,500	1
D09	HINGED DOOR	4,000	2,700	1
D10	SLIDING DOOR	3,400	2,500	2
D12	SLIDING DOOR	3,050	2,700	2

WINDOW SCHEDULE					
ID	WINDOW TYPE	WIDTH	HEIGHT	SILL HEIGHT	QUANTL.
W01	FIXED WINDOW	3,000	800	1,800	4
W02	SLIDING WINDOW	2,000	1,500	1,200	2
W03	AWNING WINDOW	1,090	1,800	900	2
W04	AWNING WINDOW	1,100	1,800	900	4
W05	AWNING WINDOW	900	1,800	900	2
W06	SLIDING WINDOW	2,800	670	930	2
W07	SLIDING WINDOW	2,200	670	930	2
W08	SLIDING WINDOW	1,500	900	1,800	4
W09	AWNING WINDOW	1,200	1,800	900	2
W10	AWNING WINDOW	850	2,100	600	4
W11	AWNING WINDOW	900	900	1,800	2

W12	AWNING WINDOW	1,000	1,700	1,000	2
W13	AWNING WINDOW	900	2,700	0	2
W14	AWNING WINDOW	1,100	900	1,800	2
W15	FIXED WINDOW	2,000	2,600	0	2
W16	FIXED WINDOW	2,610	2,600	0	2
W17	FIXED WINDOW	3,650	740	300	2
W18	FIXED WINDOW	4,000	740	300	2
W19	FIXED WINDOW	1,800	1,600	1,000	2
W20	SLIDING WINDOW	1,800	1,200	1,500	4
W21	SLIDING WINDOW	1,800	1,600	1,100	2
					52

LEVEL 01

SCALE 1:100



0007924100 28 Jul 2022
Assessor Shafee Hassan
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LEGEND

- 200MM DINCEL WALL
- 250MM BRICK VENEER CONSTRUCTION
- 270MM DOUBLE BRICK CONSTRUCTION
- 110MM SINGLE BRICK CONSTRUCTION
- 110MM STUD WALL
- 200MM BLOCK WALL CONSTRUCTION


EX XXXX EXISTING NATURAL GROUND LEVELS

30 SET DOWN IN BATHROOMS

XXXX SSL - STRUCTURAL SLAB LEVEL

EXISTING STRUCTURES TO BE DEMOLISHED.

- GENERAL NOTES:
- Written dimensions to take precedence over scale
 - Builder to verify all boundary clearances and site set out dimensions prior to commencement of construction
 - Levels and contours are based on supplied datum, prior to construction the relevant authority should be contacted for possible minimum floor level requirements and flood information
 - All works to be carried out in accordance with the Building Code of Australia, all Local and State Government Ordinances, relevant Australian Standards, Local Electricity and Water Authorities concerned.
 - All structural work and site drainage to be subject to the Engineers details or certification where required by Council.
 - Articulation joints in masonry to be provided as per Engineers Details and/or in accordance with BCA clause 3.3.1.8
 - Retaining walls are required to be engineer designed and certified where required.
 - All plumbing works to be strictly in accordance with A.S. 3500 and approved by relevant authorities.
 - All drawings are to be read in conjunction with the Engineer's Structural Drawings.
 - All windows and glazing to comply with A.S. 1288 & A.S. 2047.
 - Batters to comply with appropriate soil classification described in Table 3.1.1.1 BCA Vol 2
 - Engineer to provide design to address loadings if built in close proximity to sewer, stormwater easements.
 - Vehicular crossover to be constructed as per Council requirements.
 - Articulated joints in accordance with BCA 3.3.1.8 (Vol2)
 - Ventilation to be to be an exhaust fan in accordance with BCA-14.5 & As-1668.2
 - Provide cold water connection & go to dishwasher space
 - Hotwater system to comply with A.S.3500
 - Downpipes to be a maximum 12m spacing and adjacent to valley intersections
 - Drainage to be in accordance with part 3 of the BCA, point of discharge to meet local authority requirement

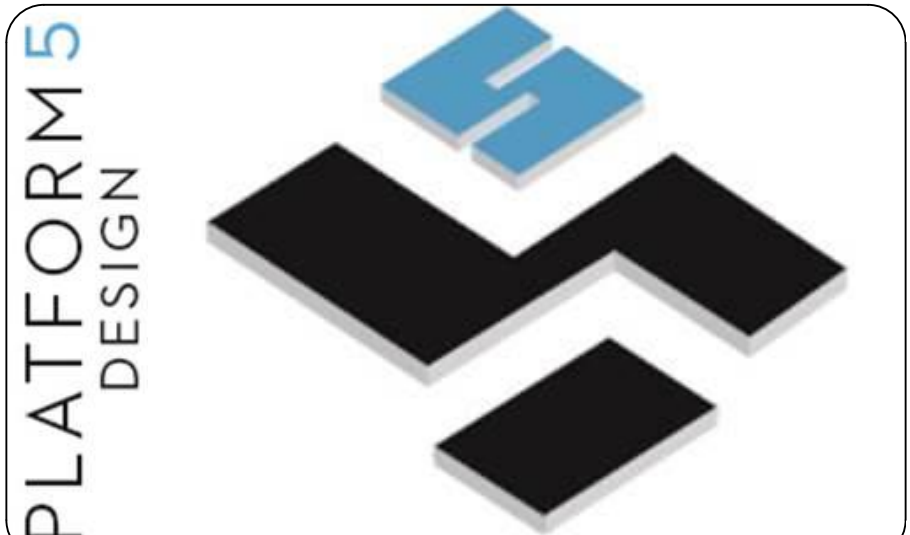

16 RAILWAY PARADE, BURWOOD, NSW, SYDNEY - 2134-

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PROJECT TITLE

21 EDGAR STREET, YAGOONA - NSW - 2199

CLIENT

VISCONA DEVELOPMENT GROUP PTY LTD

REV	DESCRIPTION	DATE
A	ISSUE FOR INFORMATION	14/06/2022
B	ISSUE FOR CONSULTANTS	15/06/2022
C	ISSUE FOR DA SUBMISSION	30/07/2022

DRAWING TITLE: ROOF	PROJECT NUMBER: 22-025
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DRAWING NUMBER: **DA2004**

DATE OF ISSUE **30/07/2022**

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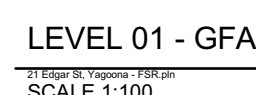
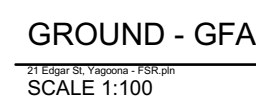
SCALE: **AS SHOWN**

DEVELOPMENT APPLICATION







ROOF
SCALE 1:100




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- LEGEND**

	200MM DINCEL WALL
	250MM BRICK VENEER CONSTRUCTION
	270MM DOUBLE BRICK CONSTRUCTION
	110MM SINGLE BRICK CONSTRUCTION
	110MM STUD WALL
	200MM BLOCK WALL CONSTRUCTION

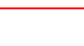EX XXXX	EXISTING NATURAL GROUND LEVELS
	SET DOWN IN BATHROOMS
	SSL - STRUCTURAL SLAB LEVEL
	EXISTING STRUCTURES TO BE DEMOLISHED

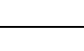GENERAL NOTES

- GENERAL NOTES:**
1. Within dimensions to take precedence over site set
 2. Builder to verify all boundary clearances and scale out dimensions prior to commencement of construction
 3. Levels and dimensions are based on supplied datum, prior to construction the relevant authority should be contacted for possible minimum floor level requirements and flood information.
 4. All work to be carried out in accordance with the Building Code of Australia, all Local and State Government Ordinances, relevant Australian Standards, Local Electricity and Water Authorities concerned.
 5. All structural and site drainage to be subject to the Engineers details or certification where required by Council.
 6. Retaining joints in masonry to be provided as per Engineers Details and/or in accordance with AS 4673-2001
 7. Articulation points are required to be engineered and certified where required.
 8. All plumbing works to be strictly in accordance with AS 3500 and approved by relevant authorities.
 9. All drawings are to be read in conjunction with the Engineer's Structural Drawings
 10. All windows and glazing to comply with AS 1288 & AS 1297
 11. Satisfactory with the Council and the Engineer's approval in accordance with Clause 3.1.1.1 BGA Vol 2
 12. Engineer to provide design to address footings if all in close proximity to severe, stormwater easements.
 13. Vehicular crossover to be constructed as per Council requirements
 14. Articulated joints in accordance with BGA 3.3.1.3 (Voert)
 15. Ventilation to work to be an exhaust fan in accordance with BCA-4.4.5 & AS-1668.2
 16. Provide cold water connection to gully to dishwasher space
 17. Hot water system to comply with AS 3500
 18. Downpipes to be a maximum 12mm spacing and adjacent to valley interferences
 19. Drainage to be in accordance with part 3 of the BCA point
 20. To meet local authority requirements




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LEGEND

- 200MM DINCEL WALL
- 250MM BRICK VENEER CONSTRUCTION
- 270MM DOUBLE BRICK CONSTRUCTION
- 110MM SINGLE BRICK CONSTRUCTION
- 110MM STUD WALL
- 200MM BLOCK WALL CONSTRUCTION
- EX XXXX EXISTING NATURAL GROUND LEVELS
- 30 SET DOWN IN BATHROOMS
- XXXX SSL - STRUCTURAL SLAB LEVEL
- EXISTING STRUCTURES TO BE DEMOLISHED.

- GENERAL NOTES:
- Written dimensions to take precedence over scale
 - Builder to verify all boundary clearances and site set out dimensions prior to commencement of construction
 - Levels and contours are based on supplied datum, prior to construction the relevant authority should be contacted for possible minimum floor level requirements and flood information
 - All works to be carried out in accordance with the Building Code of Australia, all Local and State Government Ordinances, relevant Australian Standards, Local Electricity and Water Authorities concerned.
 - All structural work and site drainage to be subject to the Engineers details or certification where required by Council.
 - Articulation joints in masonry to be provided as per Engineers Details and/or in accordance with BCA clause 3.3.1.6
 - Retaining walls are required to be engineer designed and certified where required.
 - All plumbing works to be strictly in accordance with A.S. 3500 and approved by relevant authorities.
 - All drawings are to be read in conjunction with the Engineer's Structural Drawings.
 - All windows and glazing to comply with A.S. 1288 & A.S. 2047.
 - Batters to comply with appropriate soil classification described in Table 3.1.1.1 BCA Vol 2
 - Engineer to provide design to address footings if built in close proximity to sewer, stormwater easements.
 - Vehicular crossover to be constructed as per Council requirements.
 - Articulated joints in accordance with BCA 3.3.1.5 (Vol2)
 - Ventilation to be to be an exhaust fan in accordance with BCA-14.5 & As-1668.2
 - Provide cold water connection & gpo to dishwasher space
 - Hotwater system to comply with A.S.3500
 - Downpipes to be a maximum 12m spacing and adjacent to valley intersections
 - Drainage to be in accordance with part 3 of the BCA, point of discharge to meet local authority requirement

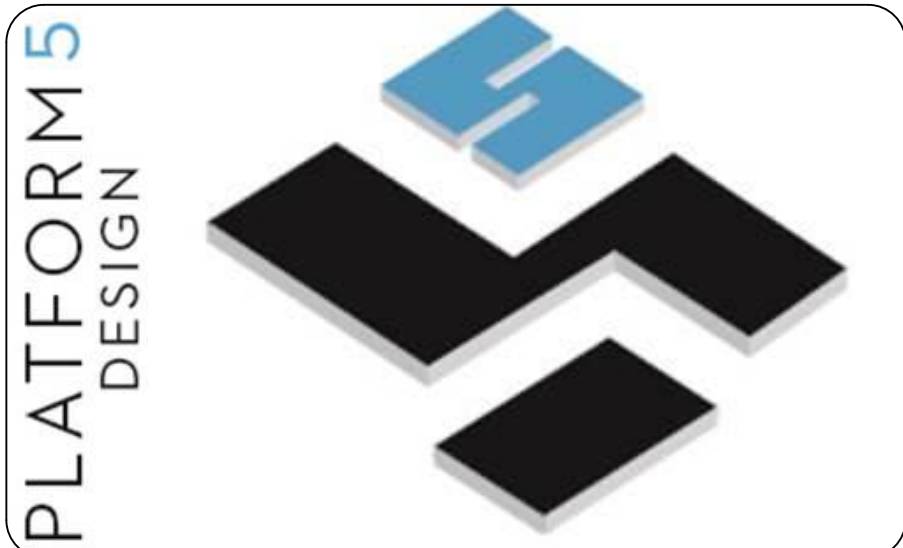

16 RAILWAY PARADE, BURWOOD, NSW, SYDNEY - 2134-

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PROJECT TITLE

21 EDGAR STREET, YAGOONA - NSW - 2199

CLIENT

VISCONA DEVELOPMENT GROUP PTY LTD

REV	DESCRIPTION	DATE
A	ISSUE FOR INFORMATION	14/06/2022
B	ISSUE FOR CONSULTANTS	15/06/2022
C	ISSUE FOR DA SUBMISSION	30/07/2022

DRAWING TITLE: SOLAR ACCESS DIAGRAMS	PROJECT NUMBER: 22-025
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DRAWING NUMBER: **DA2902**









DATE OF ISSUE: **30/07/2022**

SCALE: **AS SHOWN**

DEVELOPMENT APPLICATION

C

N

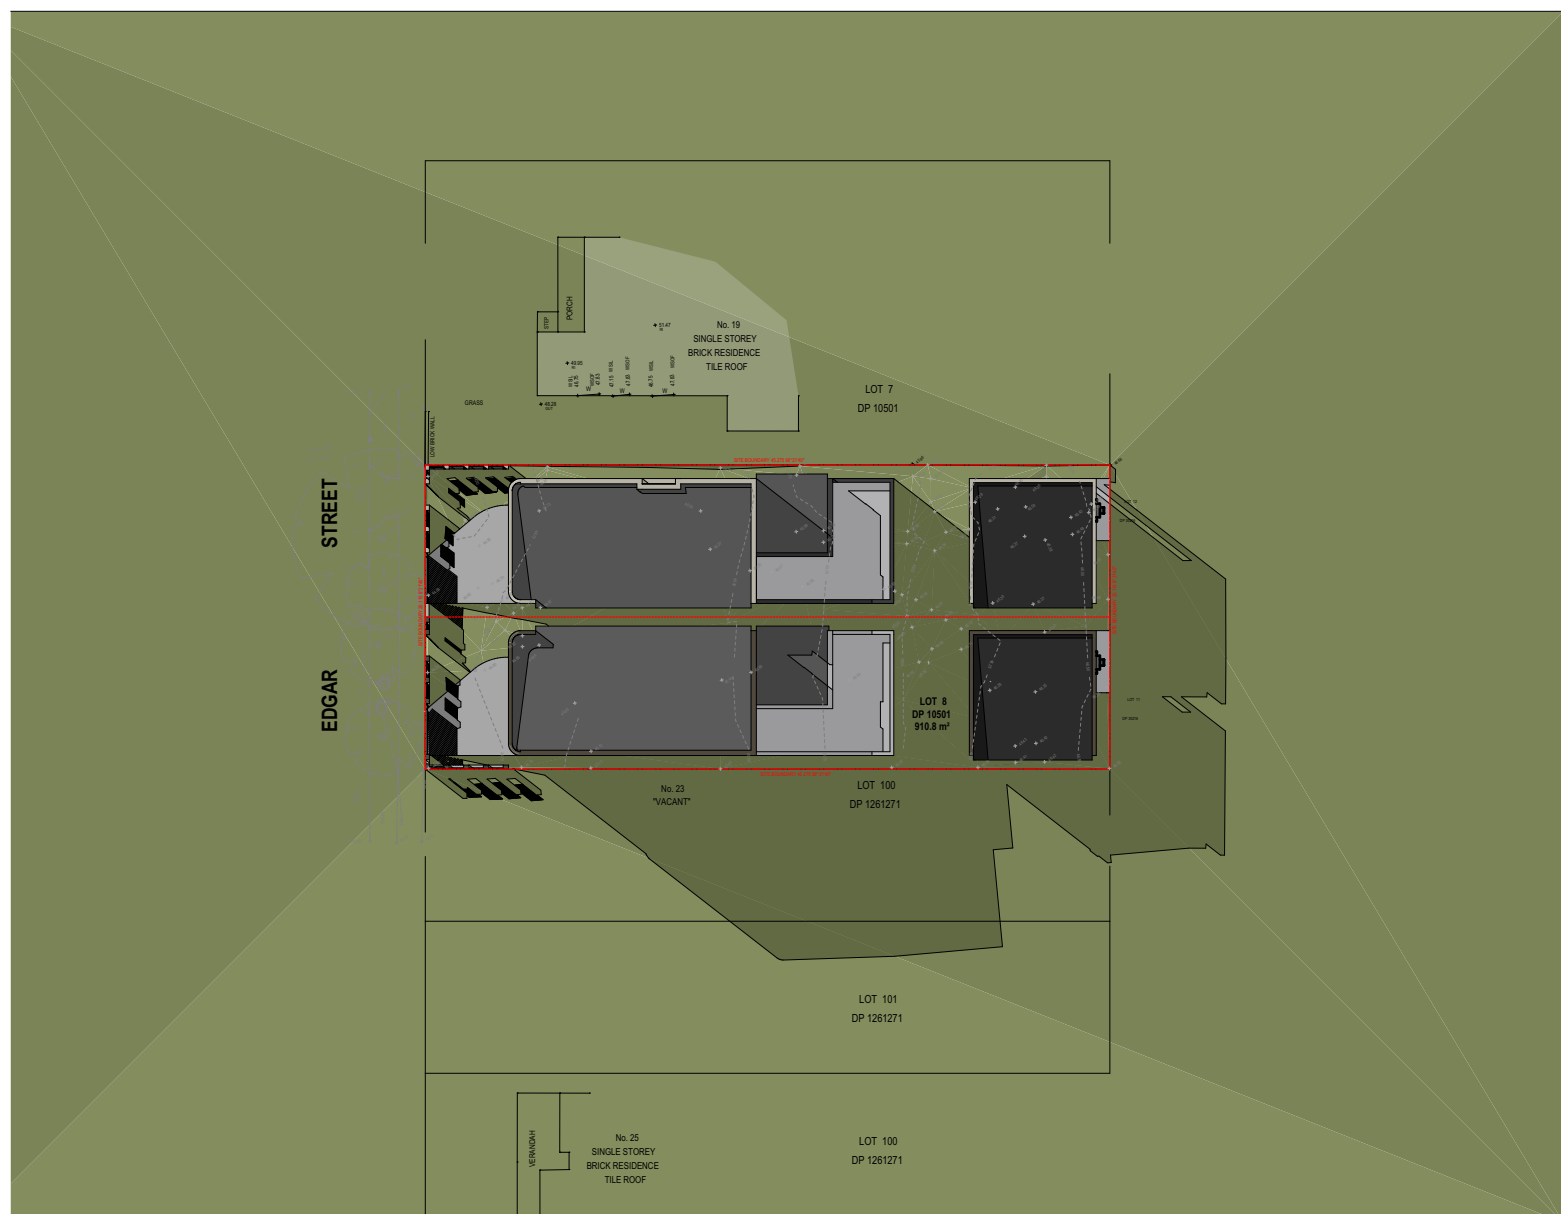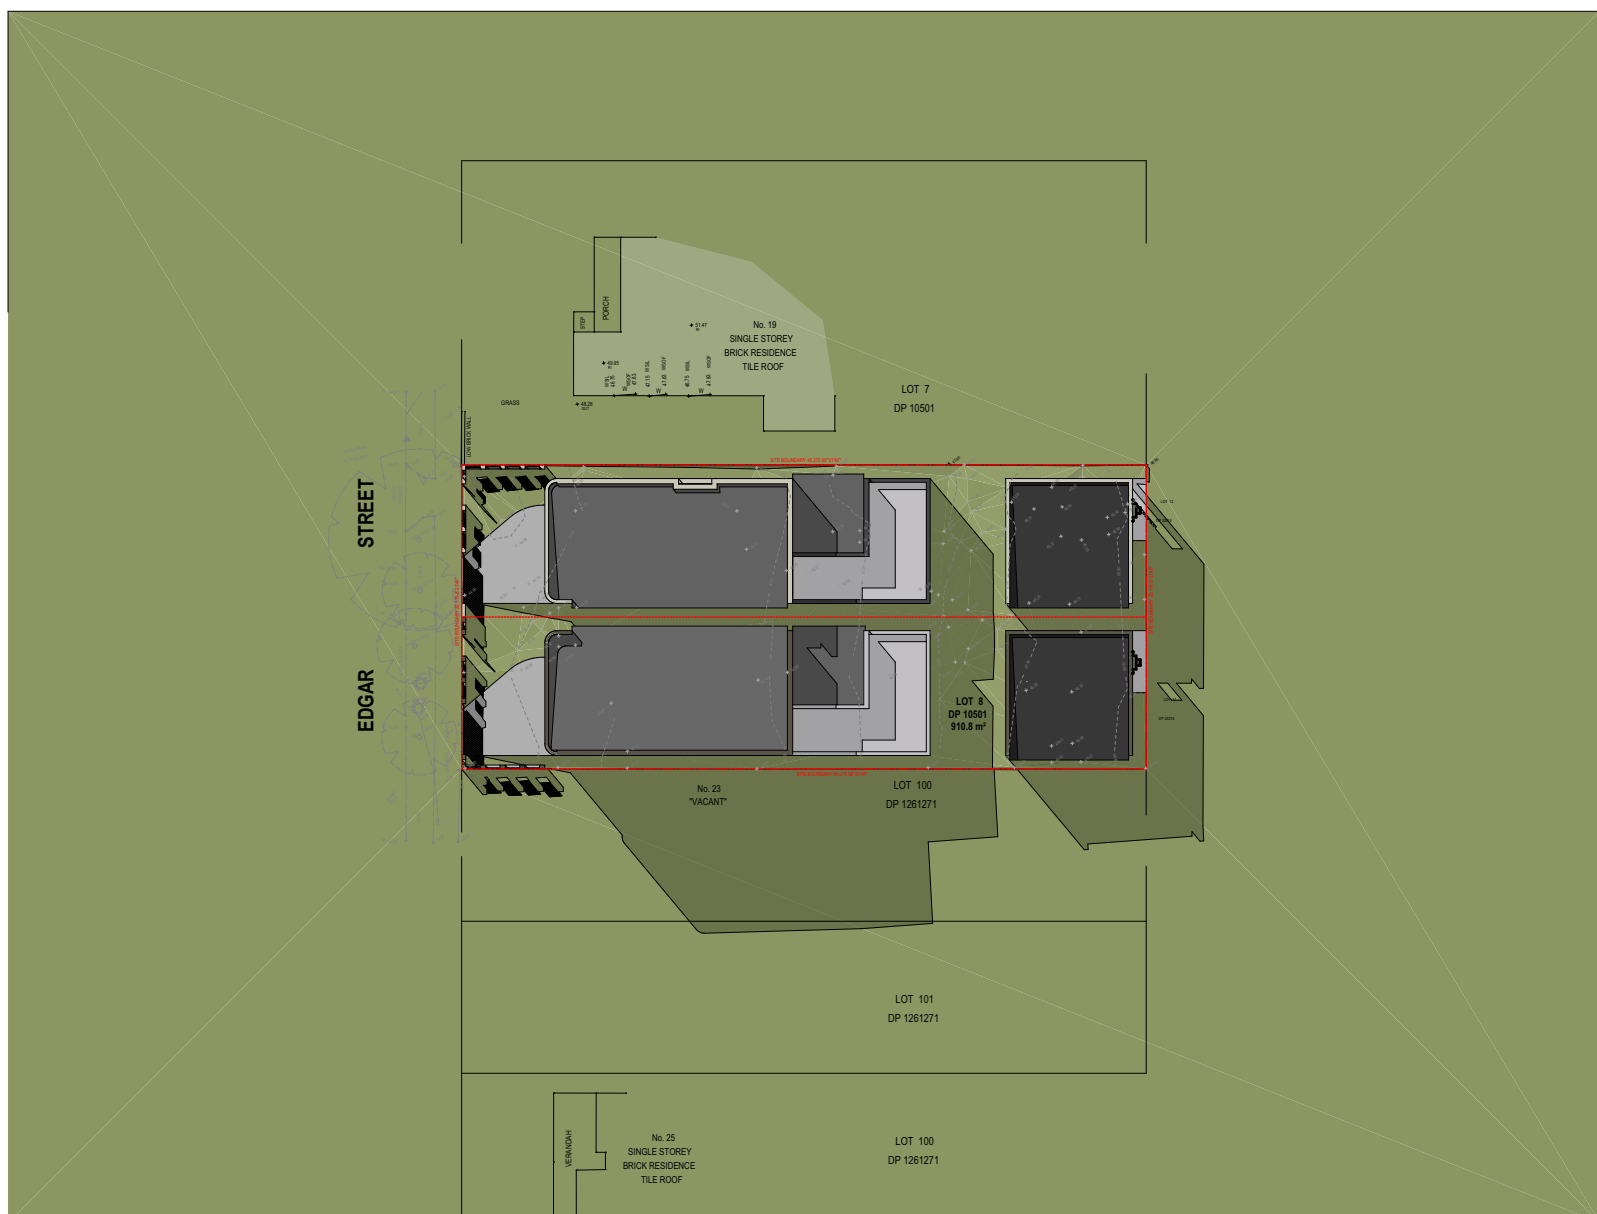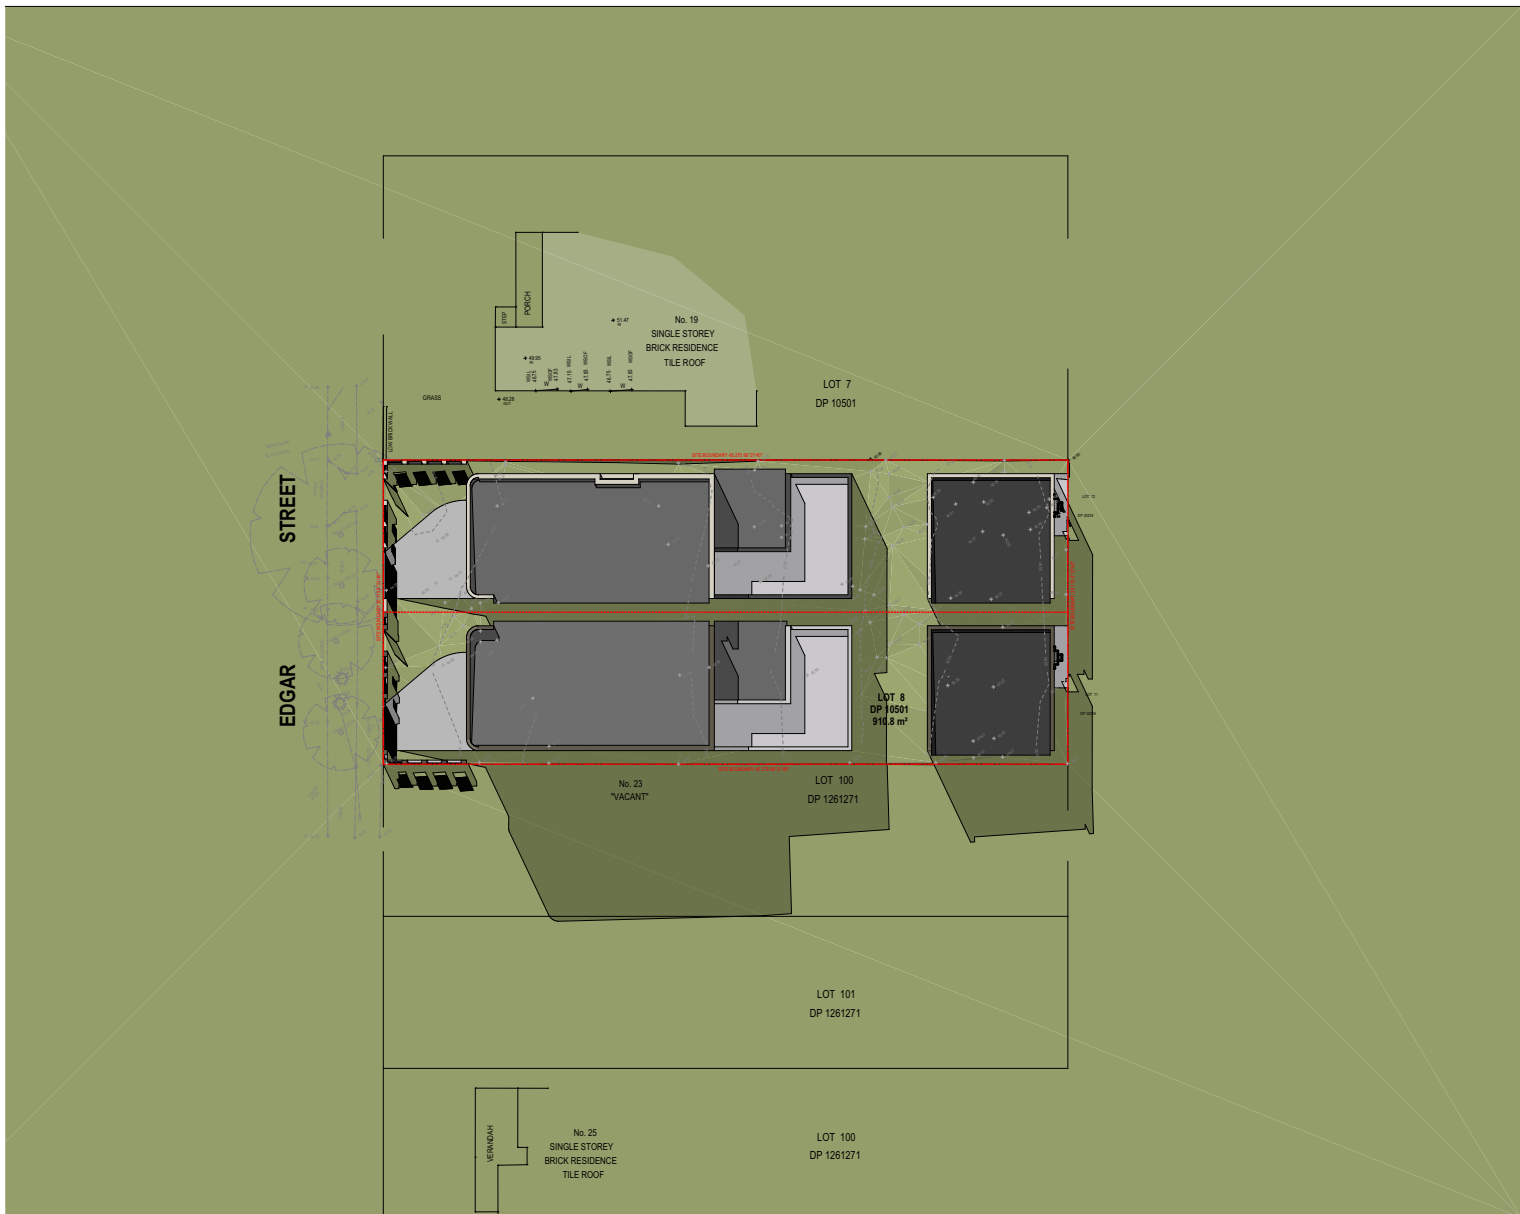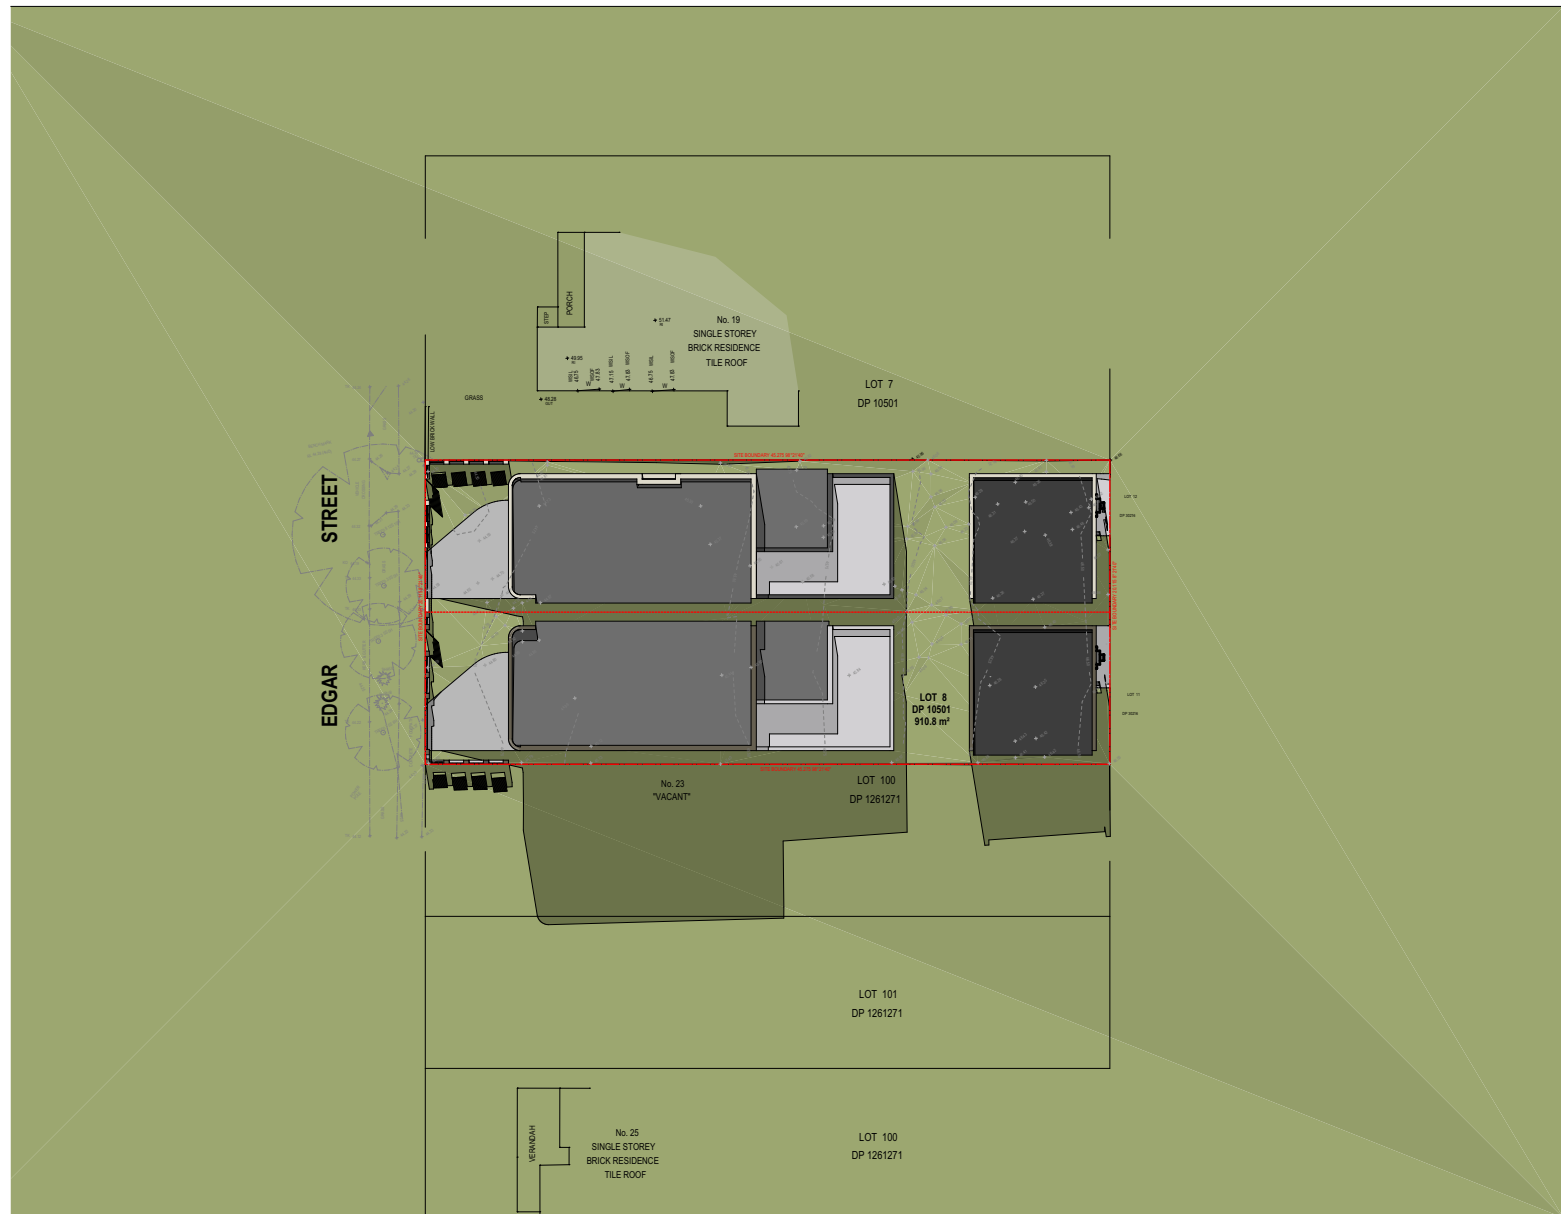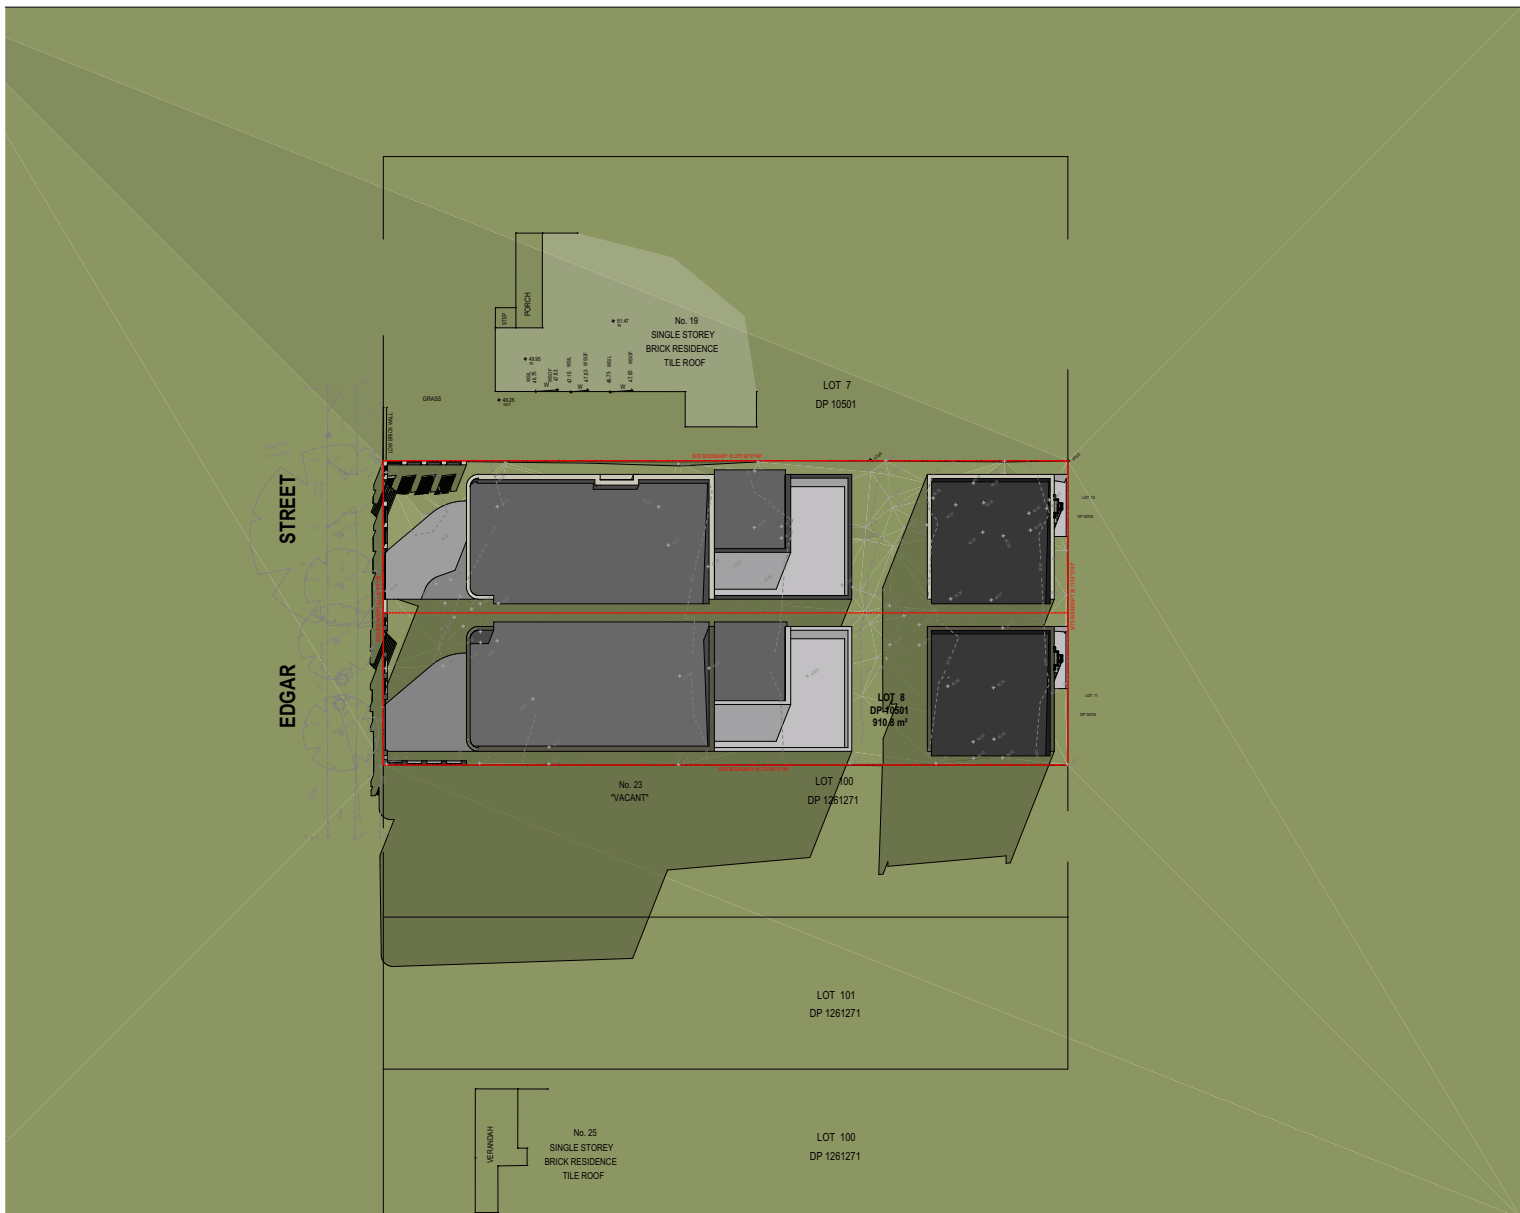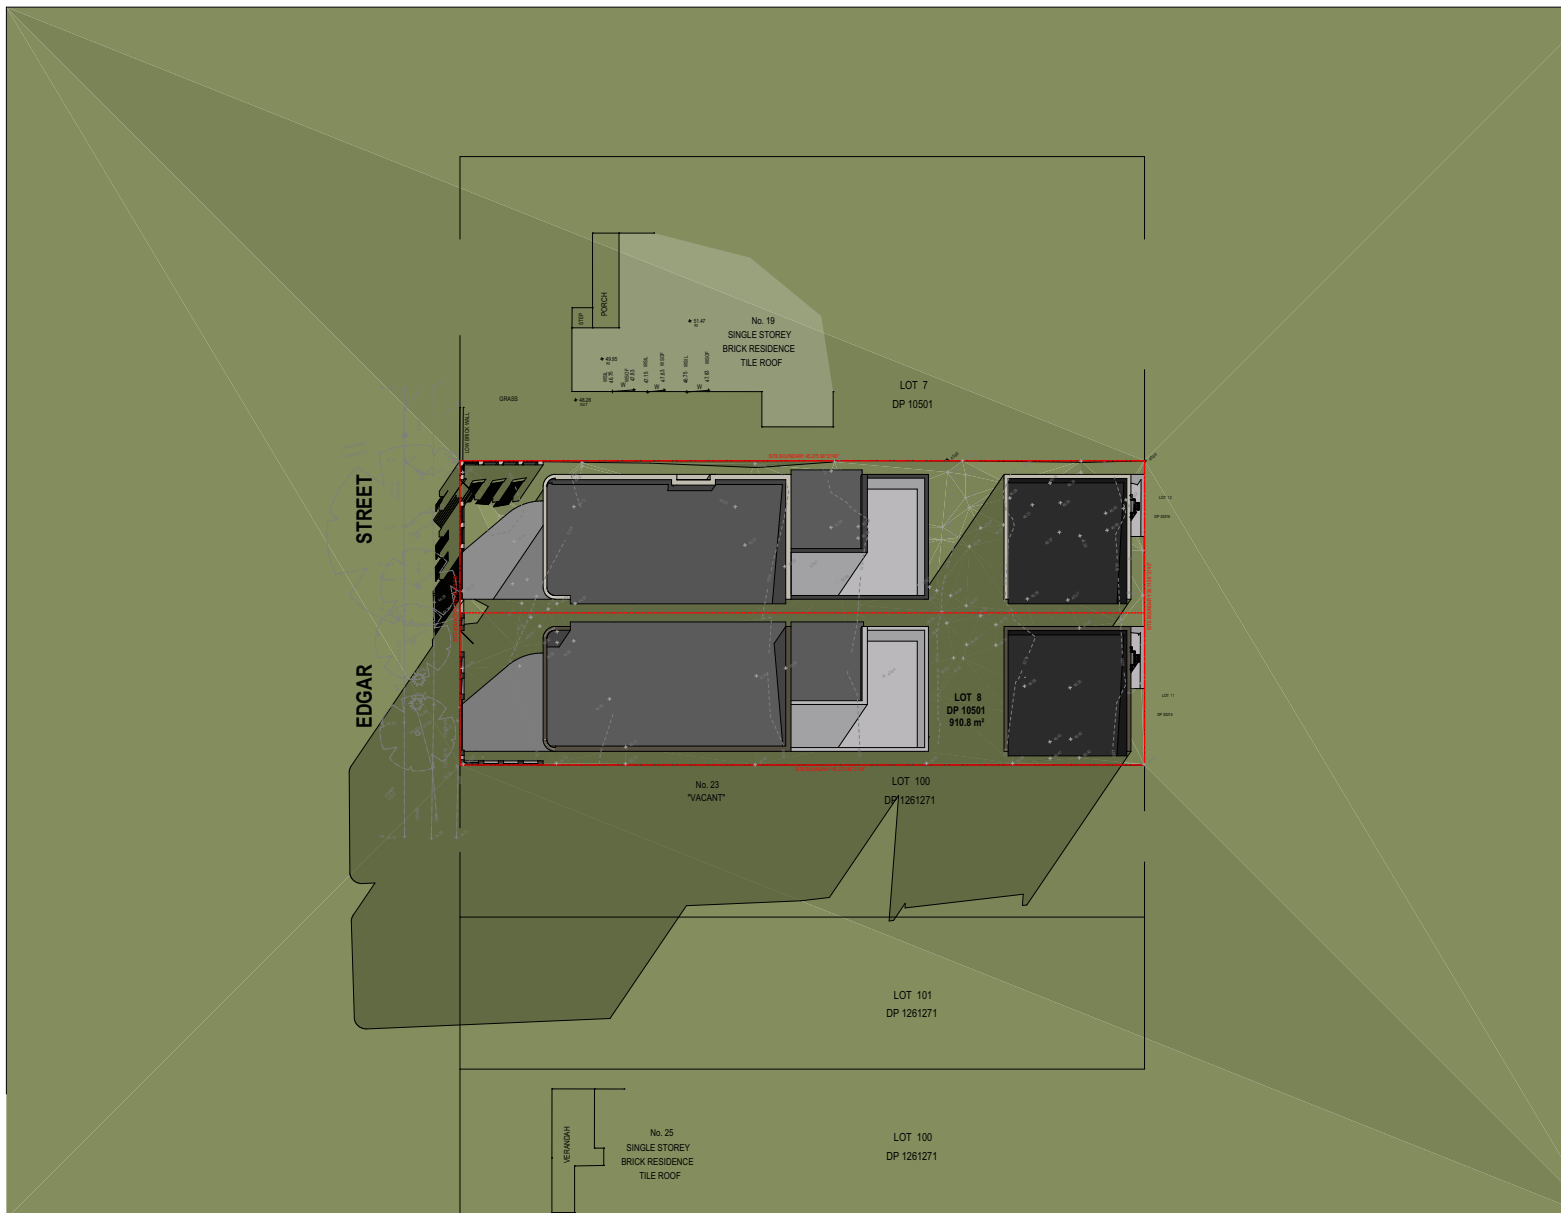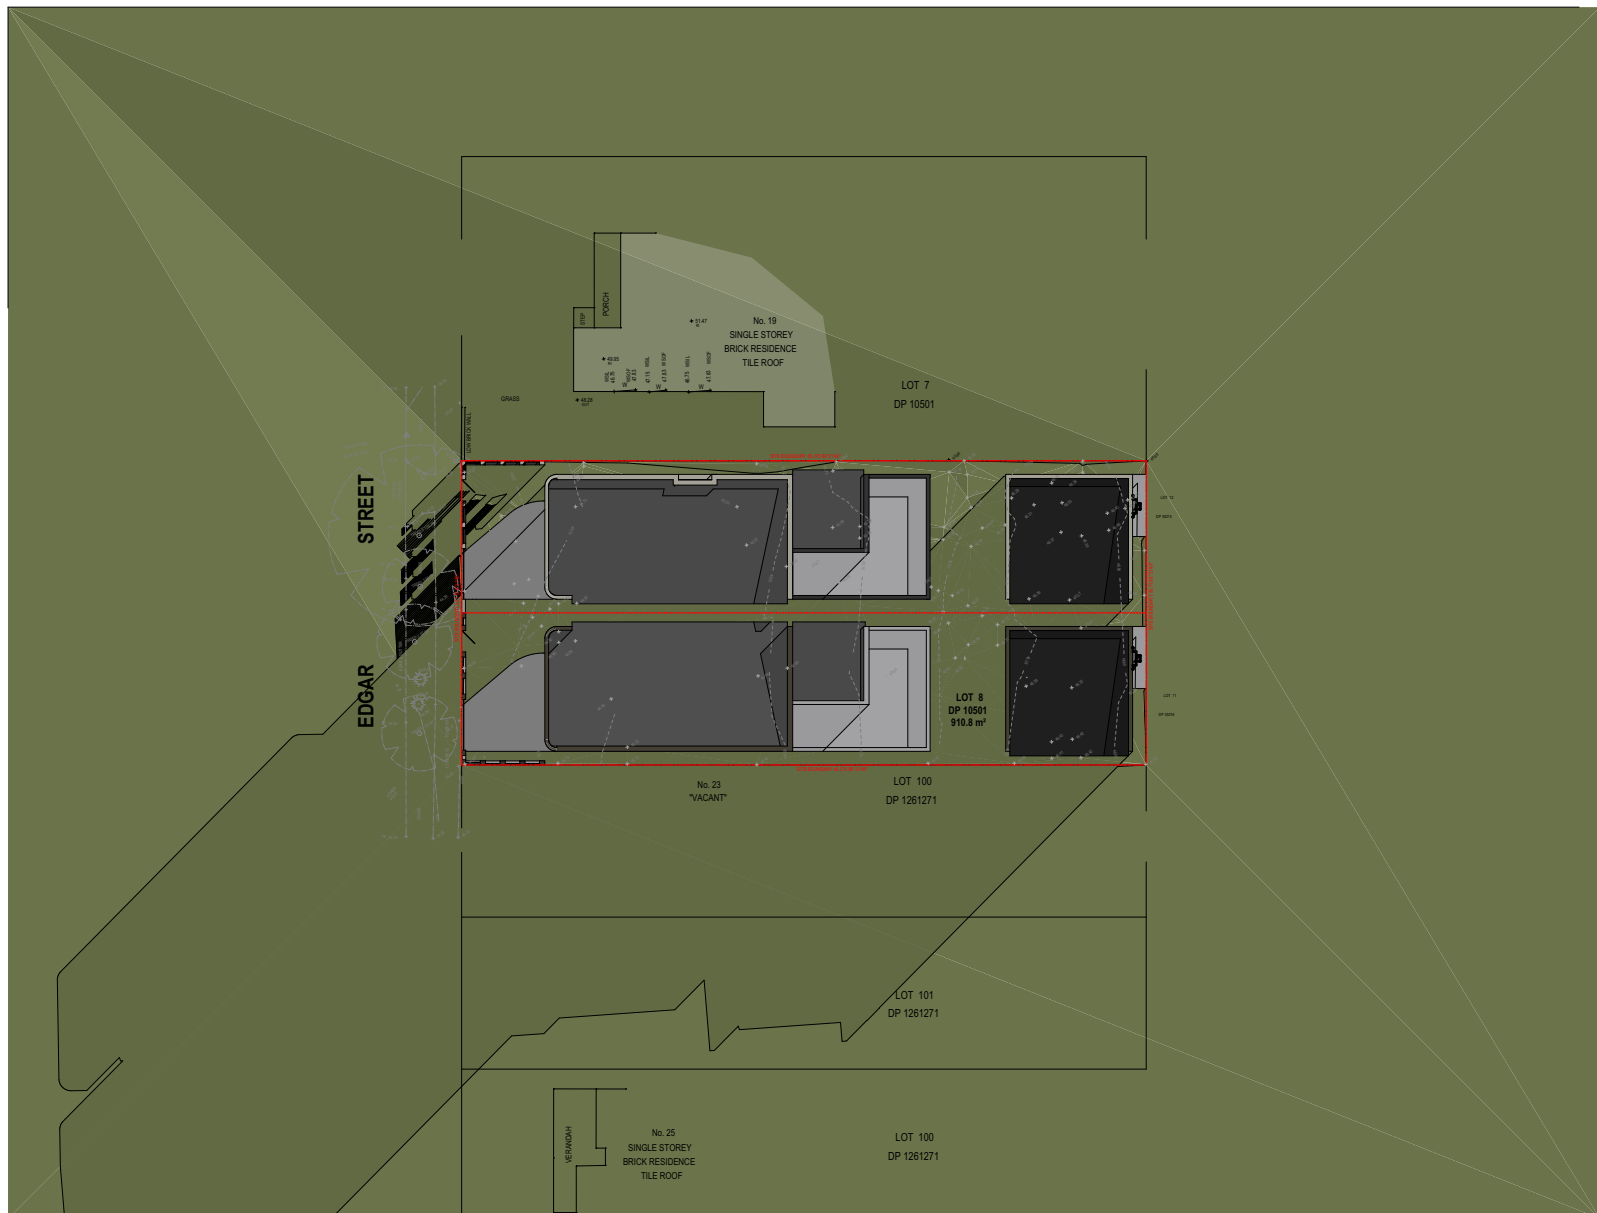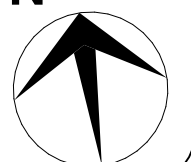

LEGEND

- 200MM DINCEL WALL
- 250MM BRICK VENEER CONSTRUCTION
- 270MM DOUBLE BRICK CONSTRUCTION
- 110MM SINGLE BRICK CONSTRUCTION
- 110MM STUD WALL
- 200MM BLOCK WALL CONSTRUCTION

EX XXXX EXISTING NATURAL GROUND LEVELS


30 SET DOWN IN BATHROOMS

XXXX SSL - STRUCTURAL SLAB LEVEL

EXISTING STRUCTURES TO BE DEMOLISHED.

GENERAL NOTES:

1. Written dimensions to take precedence over scale
2. Builder to verify all boundary clearances and site set out dimensions prior to commencement of construction
3. Levels and contours are based on supplied datum, prior to construction the relevant authority should be contacted for possible minimum floor level requirements and flood information
4. All works to be carried out in accordance with the Building Code of Australia, all Local and State Government Ordinances, relevant Australian Standards, Local Electricity and Water Authorities concerned.
5. All structural work and site drainage to be subject to the Engineers details or certification where required by Council.
6. Articulation joints in masonry to be provided as per Engineers Details and/or in accordance with BCA clause 3.3.1.8
7. Retaining walls are required to be engineer designed and certified where required.
8. All plumbing works to be strictly in accordance with A.S. 3500 and approved by relevant authorities.
9. All drawings are to be read in conjunction with the Engineer's Structural Drawings.
10. All windows and glazing to comply with A.S. 1288 & A.S. 2047.
11. Batters to comply with appropriate soil classification described in Table 3.1.1.1 BCA Vol 2
12. Engineer to provide design to address loadings if built in close proximity to sewer, stormwater easements.
13. Vehicular crossover to be constructed as per Council requirements.
14. Articulated joints in accordance with BCA 3.3.1.8 (Vo2)
15. Ventilation to be in accordance with BCA-44.5 & As-1668.2
16. Provide cold water connection & go to dishwasher space
17. Hotwater system to comply with A.S.3500
18. Downpipes to be a maximum 12m spacing and adjacent to valley intersections
19. Drainage to be in accordance with part 3 of the BCA, point of discharge to meet local authority requirement

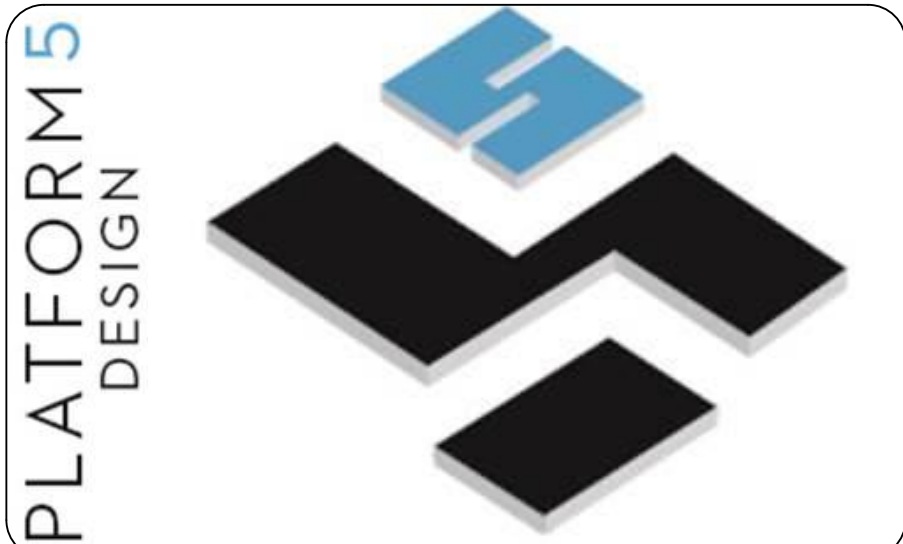

16 RAILWAY PARADE, BURWOOD, NSW, SYDNEY - 2134-

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PROJECT TITLE

21 EDGAR STREET, YAGOONA - NSW - 2199

CLIENT

VISCONA DEVELOPMENT GROUP PTY LTD

REV	DESCRIPTION	DATE
A	ISSUE FOR INFORMATION	14/06/2022
B	ISSUE FOR CONSULTANTS	15/06/2022
C	ISSUE FOR DA SUBMISSION	30/07/2022

DRAWING TITLE:

ELEVATIONS

PROJECT NUMBER:

22-025

DRAWING NUMBER: **DA3001**




DATE OF ISSUE: **30/07/2022**

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SCALE: **AS SHOWN**

DEVELOPMENT APPLICATION



LEGEND

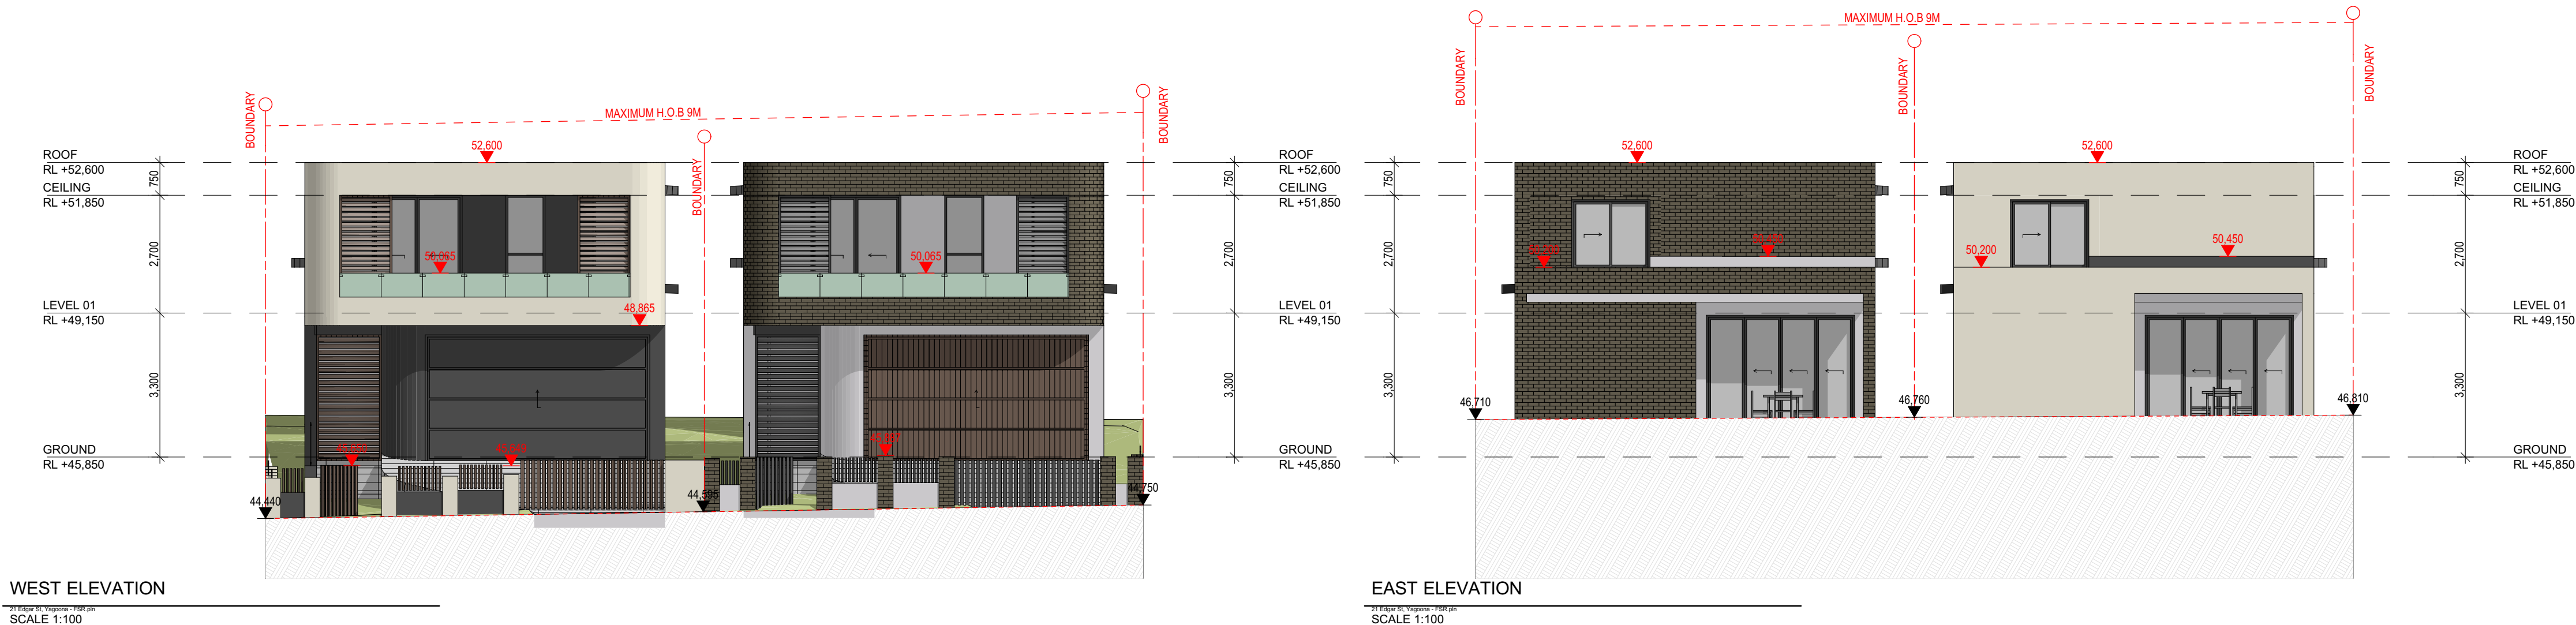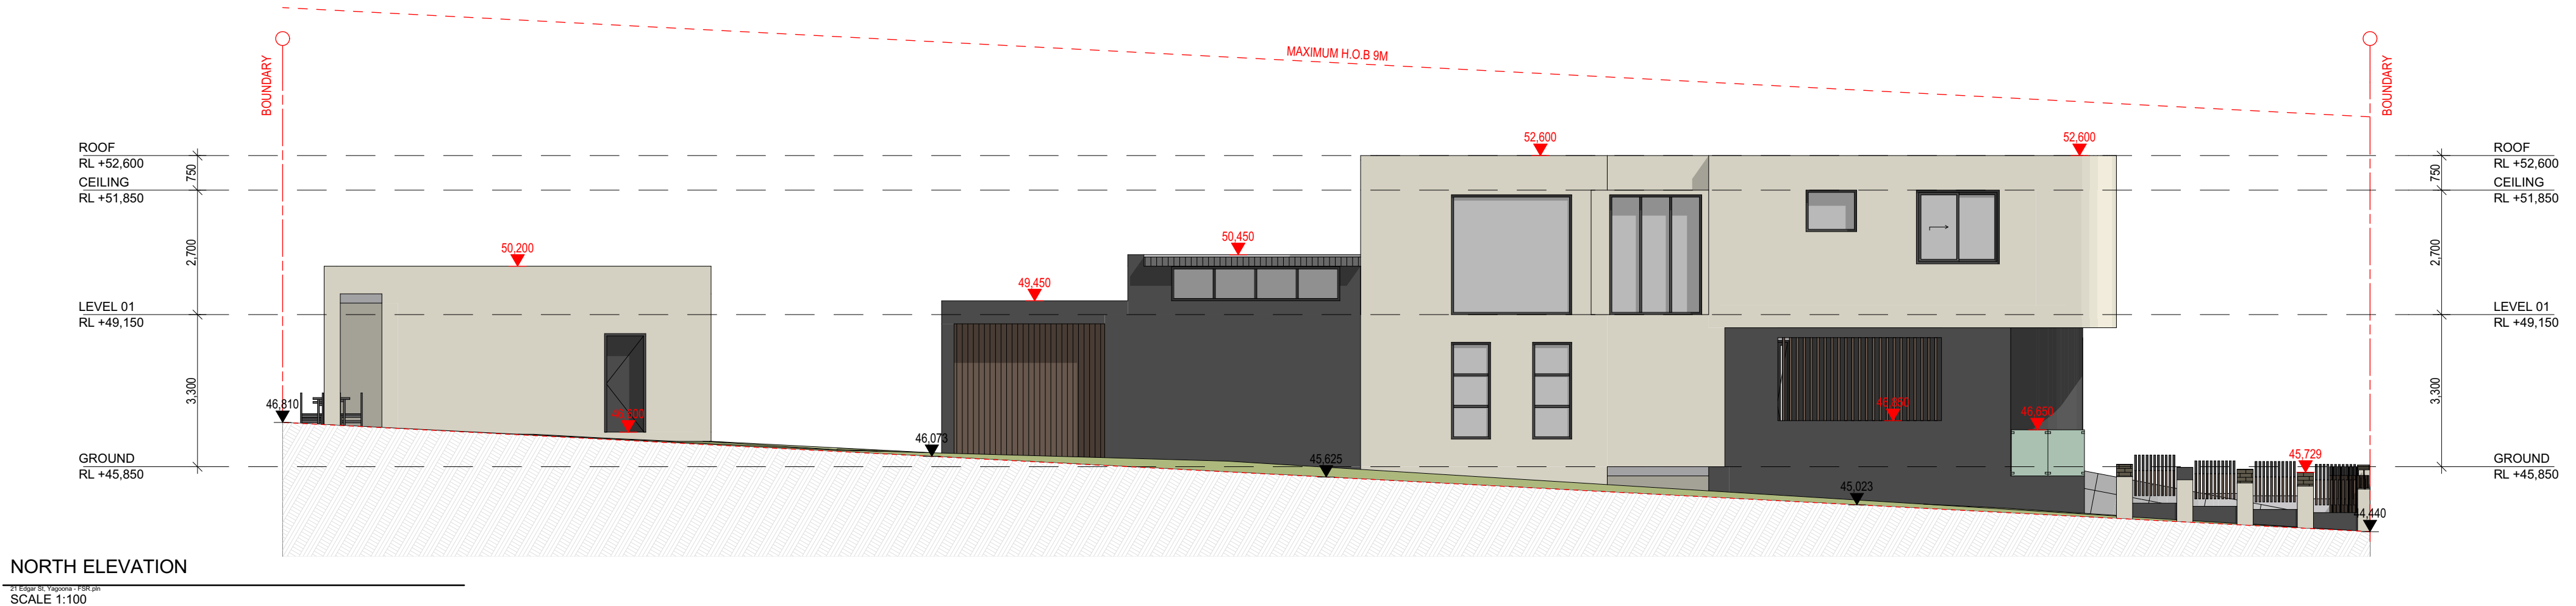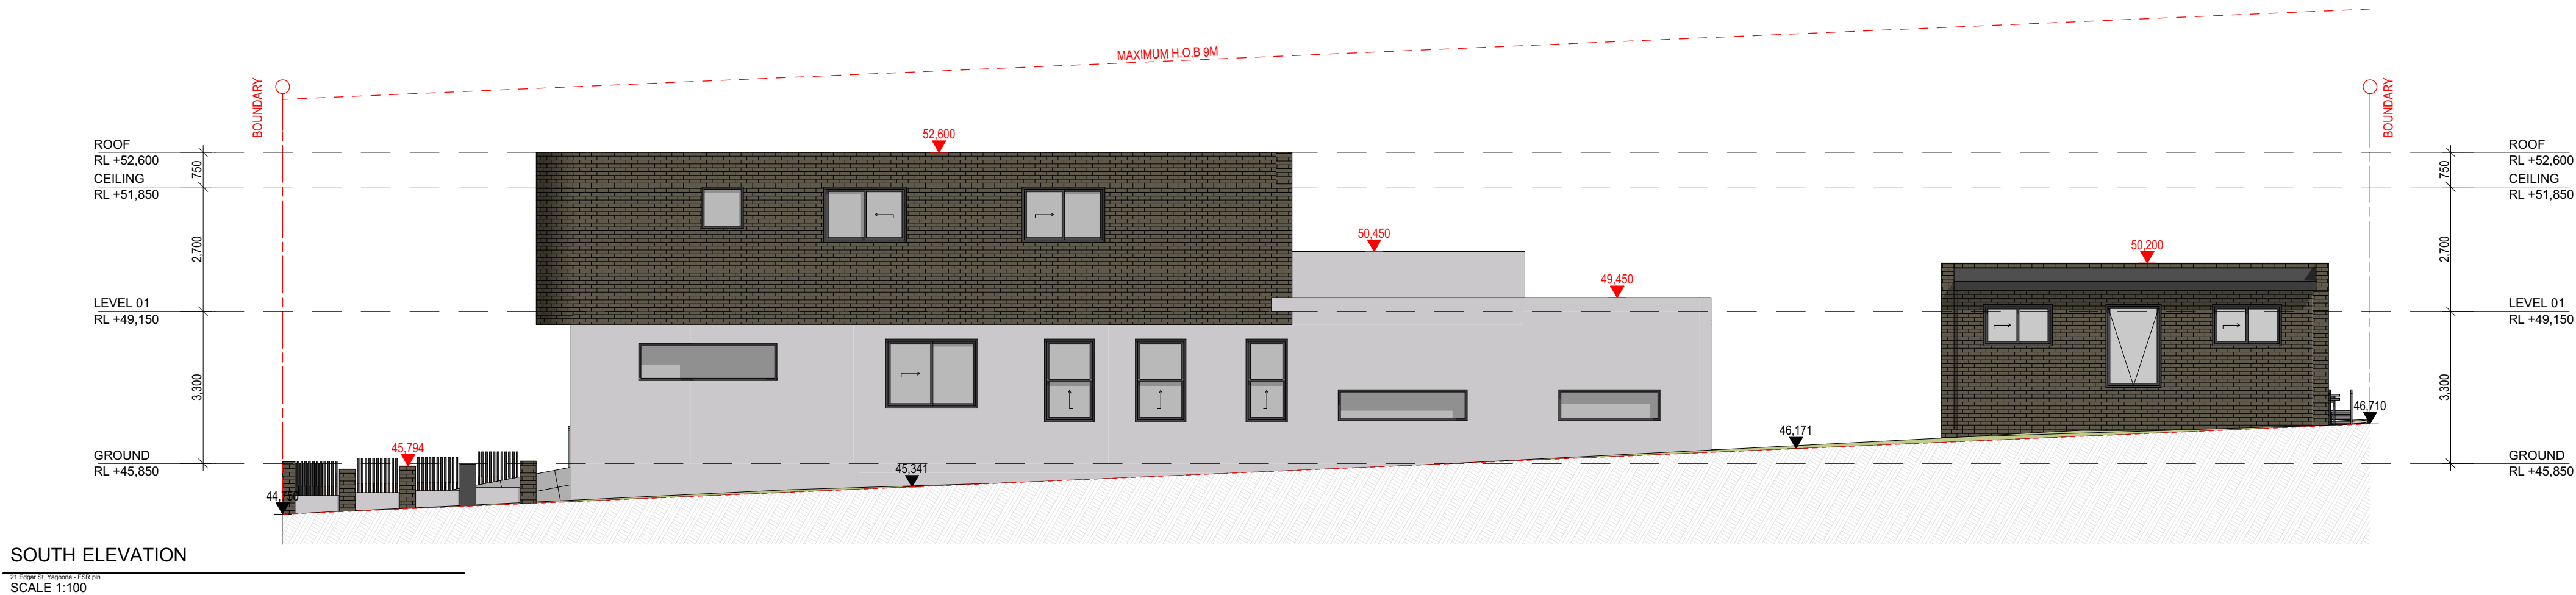	200MM DINCEL WALL
	250MM BRICK VENEER CONSTRUCTION
	270MM DOUBLE BRICK CONSTRUCTION
	110MM SINGLE BRICK CONSTRUCTION
	110MM STUD WALL
	200MM BLOCK WALL CONSTRUCTION


EX XXXX EXISTING NATURAL GROUND LEVELS

30 SET DOWN IN BATHROOMS

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 - Levels and contours are based on supplied datum, prior to construction the relevant authority should be contacted for possible minimum floor level requirements and flood information.
 - All works to be carried out in accordance with the Building Code of Australia, all Local and State Government Ordinances, relevant Australian Standards, Local Electricity and Water Authorities concerned.
 - All structural work and site drainage to be subject to the Engineers details or certification where required by Council.
 - Articulation joints in masonry to be provided as per Engineers Details and/or in accordance with BCA clause 3.3.1.6
 - Retaining walls are required to be engineer designed and certified where required.
 - All plumbing works to be strictly in accordance with A.S. 3500 and approved by relevant authorities.
 - All drawings are to be read in conjunction with the Engineer's Structural Drawings.
 - All windows and glazing to comply with A.S. 1288 & A.S. 2047.
 - Batters to comply with appropriate soil classification described in Table 3.1.1.1 BCA Vol 2
 - Engineer to provide design to address footings if built in close proximity to sewer, stormwater easements.
 - Vehicular crossover to be constructed as per Council requirements.
 - Articulated joints in accordance with BCA 3.3.1.5 (Vol2)
 - Ventilation to we to be an exhaust fan in accordance with BCA-14.5 & As-1668.2
 - Provide cold water connection & gpo to dishwasher space
 - Hotwater system to comply with A.S.3500
 - Downpipes to be a maximum 12m spacing and adjacent to valley intersections
 - Drainage to be in accordance with part 3 of the BCA, point of discharge to meet local authority requirement



STREETSCAPE ELEVATION

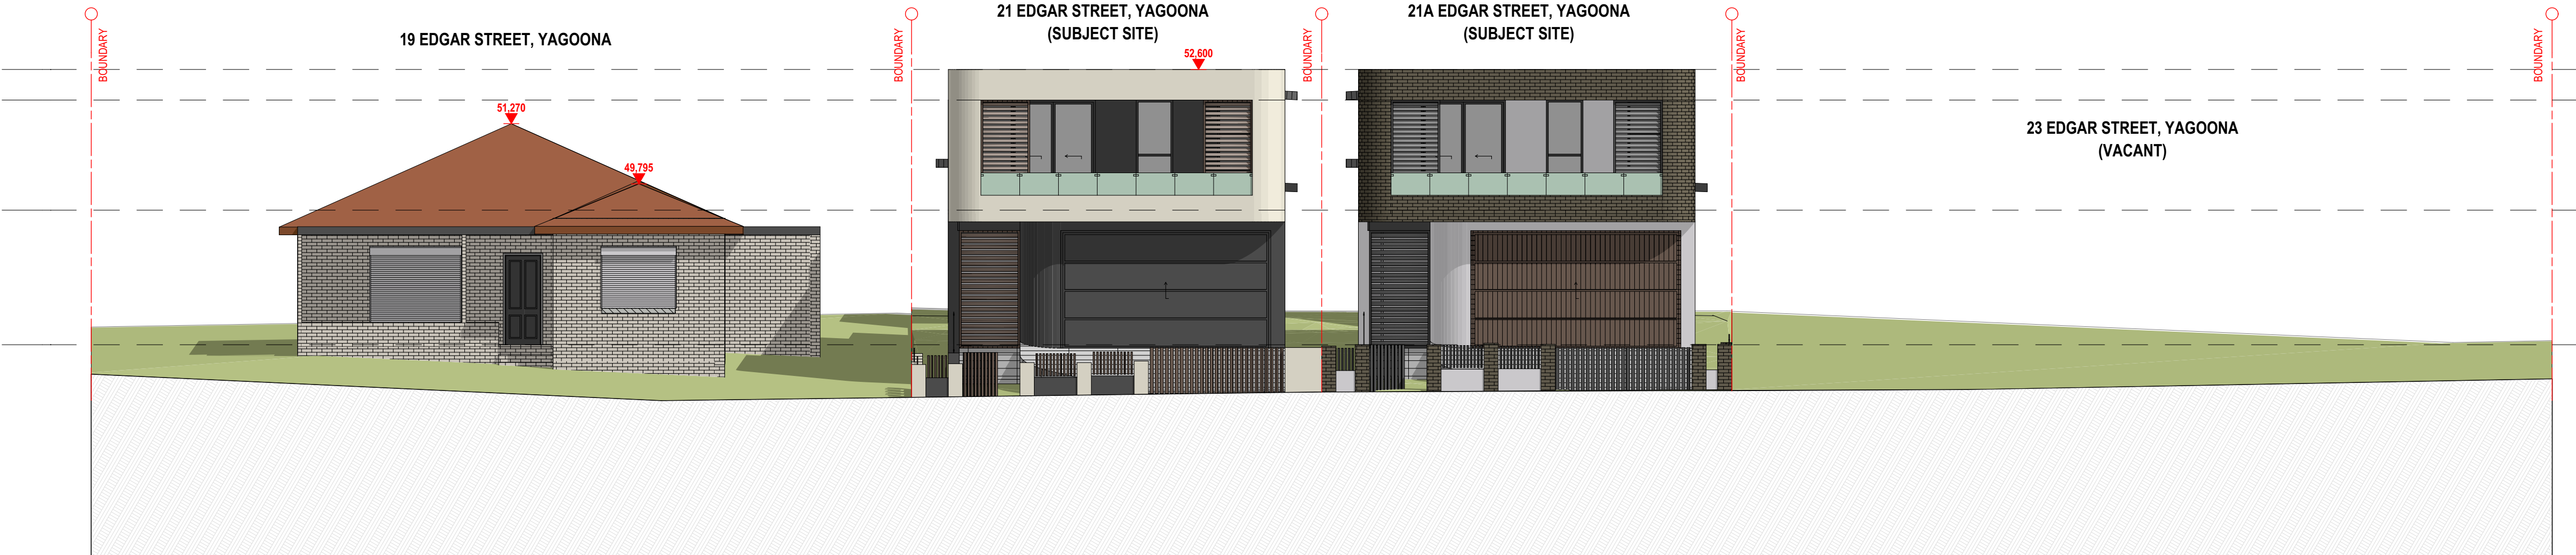SCALE 1:100

Thermal Specification				
Issued in accordance with BASIX Thermal Comfort Simulation Method.				
Assessor No #	DMN/19/1938	Projects:	YAGOONA	
Thermal performance specifications				
Following specification must apply to all instances of that element for the whole project. If different construction elements are applied then the Assessor Certificate is no longer valid.				
Certificate No:		21 EDGAR STREET(LOT-A)		
		Unit-A1(Primary)	Unit-A2(Granny)	
External walls Construction		Added Insulation		
Brick Veneer		R2.5	R2.5	
Brick Veneer(Garage)		R2.5	-	
Internal walls Construction				
Plasterboard on studs (Garage)		R2.5	-	
Plasterboard on studs		Nil	Nil	
Roof Construction				
Metal Roof		Foil+Bulk(R1.3 Anticon)	Foil+Bulk(R1.3 Anticon)	
Colour		Medium	Medium	
Ceilings Construction				
Plaster board		R3.0	R3.0	
Floors Construction		Covering		
Concrete (Slab on ground)		Default	Nil	Nil
Timber(Floor between)		Default	Nil	Nil
Timber(Above garage)		Default	R3.0	Nil
Windows				
All window and glazed door to be selected as per AFRC. Deviation is accepted ±5% . This tolerance ONLY applies to SHGC, the U-value can always be lower but not higher than the values stated.				
Area(M ²)	Frame	Ext. cover	U Val	SHGC Glazing
Unit-1A	Alum/Sliding	As drawn	4.6	0.47 Single LowE Ntrl
	Alum/Awning	As drawn	4.8	0.42 Single LowE Ntrl
	Alum/Fixed	As drawn	4.4	0.48 Single LowE Ntrl
	Alum/Sliding dr	As drawn	4.4	0.46 Single LowE Ntrl
W15 & W16	Alum/Fixed	As drawn	3.1	0.27 Dbl Low E Ntrl
	Alum/Sliding(GP-B)	As drawn	6.7	0.70 Single Clear
Unit-1B	Alum/Awning(Gp-A)	As drawn	6.7	0.57 Single Clear
Skylights				
Area (M ²)	Type	Glazing		
Nil	Nil	Nil		
Fixed shading (eaves, pergolas, verandas , awnings)				
All shade elements modelled as drawn				
Weather seals to windows and doors			Be provided	
All down lights be sealed			Yes	

BASIX Commitments

Basix Certificate No:

FOR UNIT-A1 (Primary) & A2Granny)

HOT WATER

- Gas Instantaneous -5.5 star

VENTILATION

- Bathrooms: Individual fan ducted to façade or roof with interlock to light switch
- Kitchen: individual fan, not ducted with manual ON /OFF
- Laundry:Individual fan ducted to façade or roof with manual ON /OFF

AIR CON:

- Cooling & Heating : 1- Phase Air con-EER 2.5-3.0 (Zoned)

LIGHTING

- Energy efficient light fittings (LED or fluorescent for each individual spaces)

KITCHEN

- Gas cooktop & electric oven

CLOTHES DRYING LINE

- No, In door Clothes drying line
- Yes, outdoor clothing drying line

VENTILATED SPACE

No, Ventilated refrigerated space

WATER SAVING

- 4 star shower heads
- 4 star toilets or better
- 5 star kitchen tap
- 5 Star bathroom tap

RAIN WATER&STORM WATER TANK:

- 1500 L rain water tank used for landscape & Laundry(Unit-A2)
- 1500 L rain water tank used for landscape.(Unit-A1)



0007924100 28 Jul 2022

Assessor Shafœ Hassan
Accreditation No. DMN/19/1938
Address
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YAGOONA , NSW , 2199



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Thermal Specification						
Issued in accordance with BASIX Thermal Comfort Simulation Method.						
Assessor No #	DMN/19/1938	Projects:		YAGOONA		
Thermal performance specifications						
Following specification must apply to all instances of that element for the whole project. If different construction elements are applied then the Assessor Certificate is no longer valid.						
Certificate No:		21 EDGAR STREET(LOT-B)				
		Unit-B1(Primary)		Unit-B2(Granny)		
External walls Construction		Added Insulation				
Brick Veneer		R2.5		R2.5		
Brick Veneer(Garage)		R2.5		-		
Internal walls Construction						
Plasterboard on studs (Garage)		R2.5		-		
Plasterboard on studs		Nil		Nil		
Roof Construction						
Metal Roof		Foil+Bulk(R1.3 Anticon)		Foil+Bulk(R1.3 Anticon)		
Colour		Medium		Medium		
Ceillings Construction						
Plaster board		R3.0		R3.0		
Floors Construction		Covering				
Concrete (Slab on ground)		Default		Nil		
Timber(Floor between)		Default		Nil		
Timber(Above garage)		Default		Nil		
Windows						
All window and glazed door to be selected as per AFRC. Deviation is accepted ±5% . This tolerance ONLY applies to SHGC, the U-value can always be lower but not higher than the values stated.						
Area(M ²)	Frame	Ext. cover	U Val	SHGC	Glazing	
Unit-1A	Alum/Sliding	As drawn	4.6	0.47	Single LowE Ntrl	
	Alum/Awning	As drawn	4.8	0.42	Single LowE Ntrl	
	Alum/Fixed	As drawn	4.4	0.48	Single LowE Ntrl	
	Alum/Sliding dr	As drawn	4.4	0.46	Single LowE Ntrl	
W15 & W16	Alum/Fixed	As drawn	3.1	0.27	Dbl Low E Ntrl	
	Alum/Sliding(GP-B)	As drawn	6.7	0.70	Single Clear	
Unit-1B	Alum/Awning(Gp-A)	As drawn	6.7	0.57	Single Clear	
Skylights						
Area (M ²)	Type	Glazing				
Nil	Nil	Nil				
Fixed shading (eaves, pergolas, verandas , awnings)						
All shade elements modelled as drawn						
Weather seals to windows and doors			Be provided			
All down lights be sealed			Yes			

BASIX Commitments

Basix Certificate No:

FOR UNIT-B1 (Primary) & B2Granny)

HOT WATER

- Gas Instantaneous -5.5 star

VENTILATION

- Bathrooms: Individual fan ducted to façade or roof with interlock to light switch
- Kitchen: individual fan, not ducted with manual ON /OFF
- Laundry:Individual fan ducted to façade or roof with manual ON /OFF

AIR CON:

- Cooling & Heating : 1- Phase Air con-EER 2.5-3.0 (Zoned)

LIGHTING

- Energy efficient light fittings (LED or fluorescent for each individual spaces)

KITCHEN

- Gas cooktop & electric oven

CLOTHES DRYING LINE

- No, In door Clothes drying line
- Yes, outdoor clothing drying line

VENTILATED SPACE

No, Ventilated refrigerated space

WATER SAVING

- 4 star shower heads
- 4 star toilets or better
- 5 star kitchen tap
- 5 Star bathroom tap

RAIN WATER&STORM WATER TANK:

- 1500 L rain water tank used for landscape & Laundry(Unit-B2)
- 1500 L rain water tank used for landscape.(Unit-B1)




0007924090 28 Jul 2022

Assessor Shafœ Hassan
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16 RAILWAY PARADE, BURWOOD, NSW, SYDNEY - 2134-

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PROJECT TITLE

21 EDGAR STREET, YAGOONA - NSW - 2199

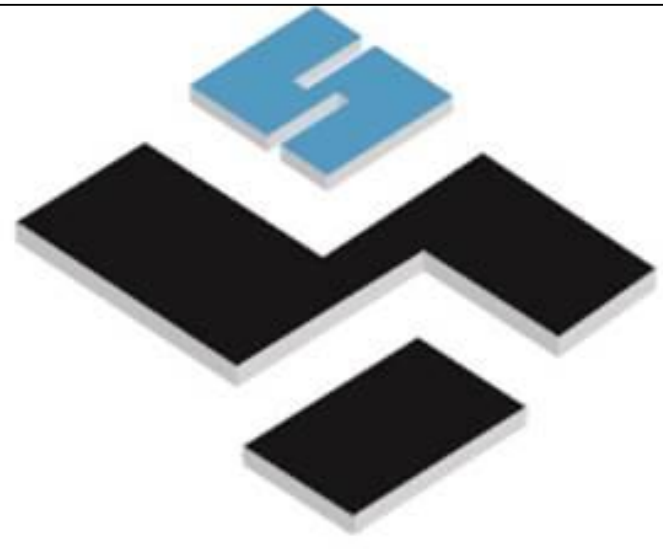
CLIENT

VISCONA DEVELOPMENT GROUP PTY LTD

REV	DESCRIPTION	DATE
A	ISSUE FOR INFORMATION	14/06/2022
B	ISSUE FOR CONSULTANTS	15/06/2022
C	ISSUE FOR DA SUBMISSION	30/07/2022

DRAWING TITLE: STREETSCAPE ELEVATION	PROJECT NUMBER: 22-025
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DRAWING NUMBER: DA3002	DATE OF ISSUE: 30/07/2022	C	N
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SCALE: AS SHOWN	
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DEVELOPMENT APPLICATION

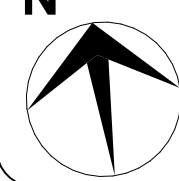

0007924100 28 Jul 2022

Assessor Shafee Hassan
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Address
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YAGOONA , NSW , 2199



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0007924090 28 Jul 2022

Assessor Shafee Hassan
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LEGEND

- 200MM DINCEL WALL
- 250MM BRICK VENEER CONSTRUCTION
- 270MM DOUBLE BRICK CONSTRUCTION
- 110MM SINGLE BRICK CONSTRUCTION
- 110MM STUD WALL
- 200MM BLOCK WALL CONSTRUCTION

EX XXXX EXISTING NATURAL GROUND LEVELS

30 SET DOWN IN BATHROOMS

XXXX SSL - STRUCTURAL SLAB LEVEL


EXISTING STRUCTURES TO BE DEMOLISHED.

- GENERAL NOTES:
- Written dimensions to take precedence over scale
 - Builder to verify all boundary clearances and site set out dimensions prior to commencement of construction
 - Levels and contours are based on supplied datum, prior to construction the relevant authority should be contacted for possible minimum floor level requirements and flood information
 - All works to be carried out in accordance with the Building Code of Australia, all Local and State Government Ordinances, relevant Australian Standards, Local Electricity and Water Authorities concerned.
 - All structural work and site drainage to be subject to the Engineers details or certification where required by Council.
 - Articulation joints in masonry to be provided as per Engineers Details and/or in accordance with BCA clause 3.3.1.6
 - Retaining walls are required to be engineer designed and certified where required.
 - All plumbing works to be strictly in accordance with A.S. 3500 and approved by relevant authorities.
 - All drawings are to be read in conjunction with the Engineer's Structural Drawings.
 - All windows and glazing to comply with A.S. 1288 & A.S. 2047.
 - Batters to comply with appropriate soil classification described in Table 3.1.1.1 BCA Vol 2
 - Engineer to provide design to address footings if built in close proximity to sewer, stormwater easements.
 - Vehicular crossover to be constructed as per Council requirements.
 - Articulated joints in accordance with BCA 3.3.1.5 (Vol2)
 - Ventilation to be to be an exhaust fan in accordance with BCA-14.5 & As-1668.2
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 - Downpipes to be a maximum 12m spacing and adjacent to valley intersections
 - Drainage to be in accordance with part 3 of the BCA, point of discharge to meet local authority requirement




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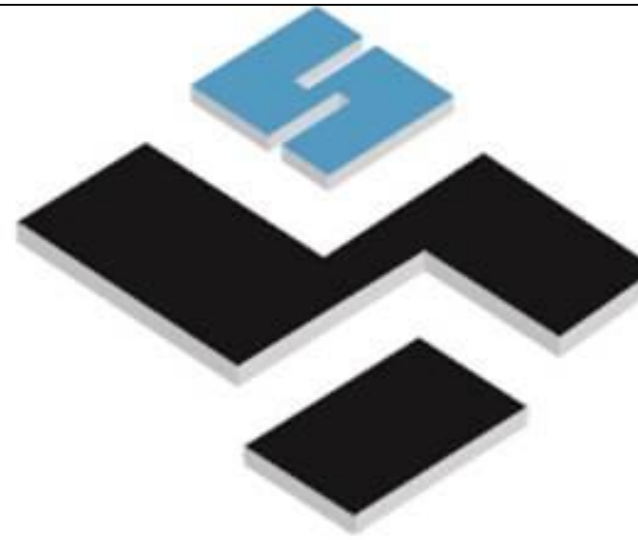
SCALE 1:100

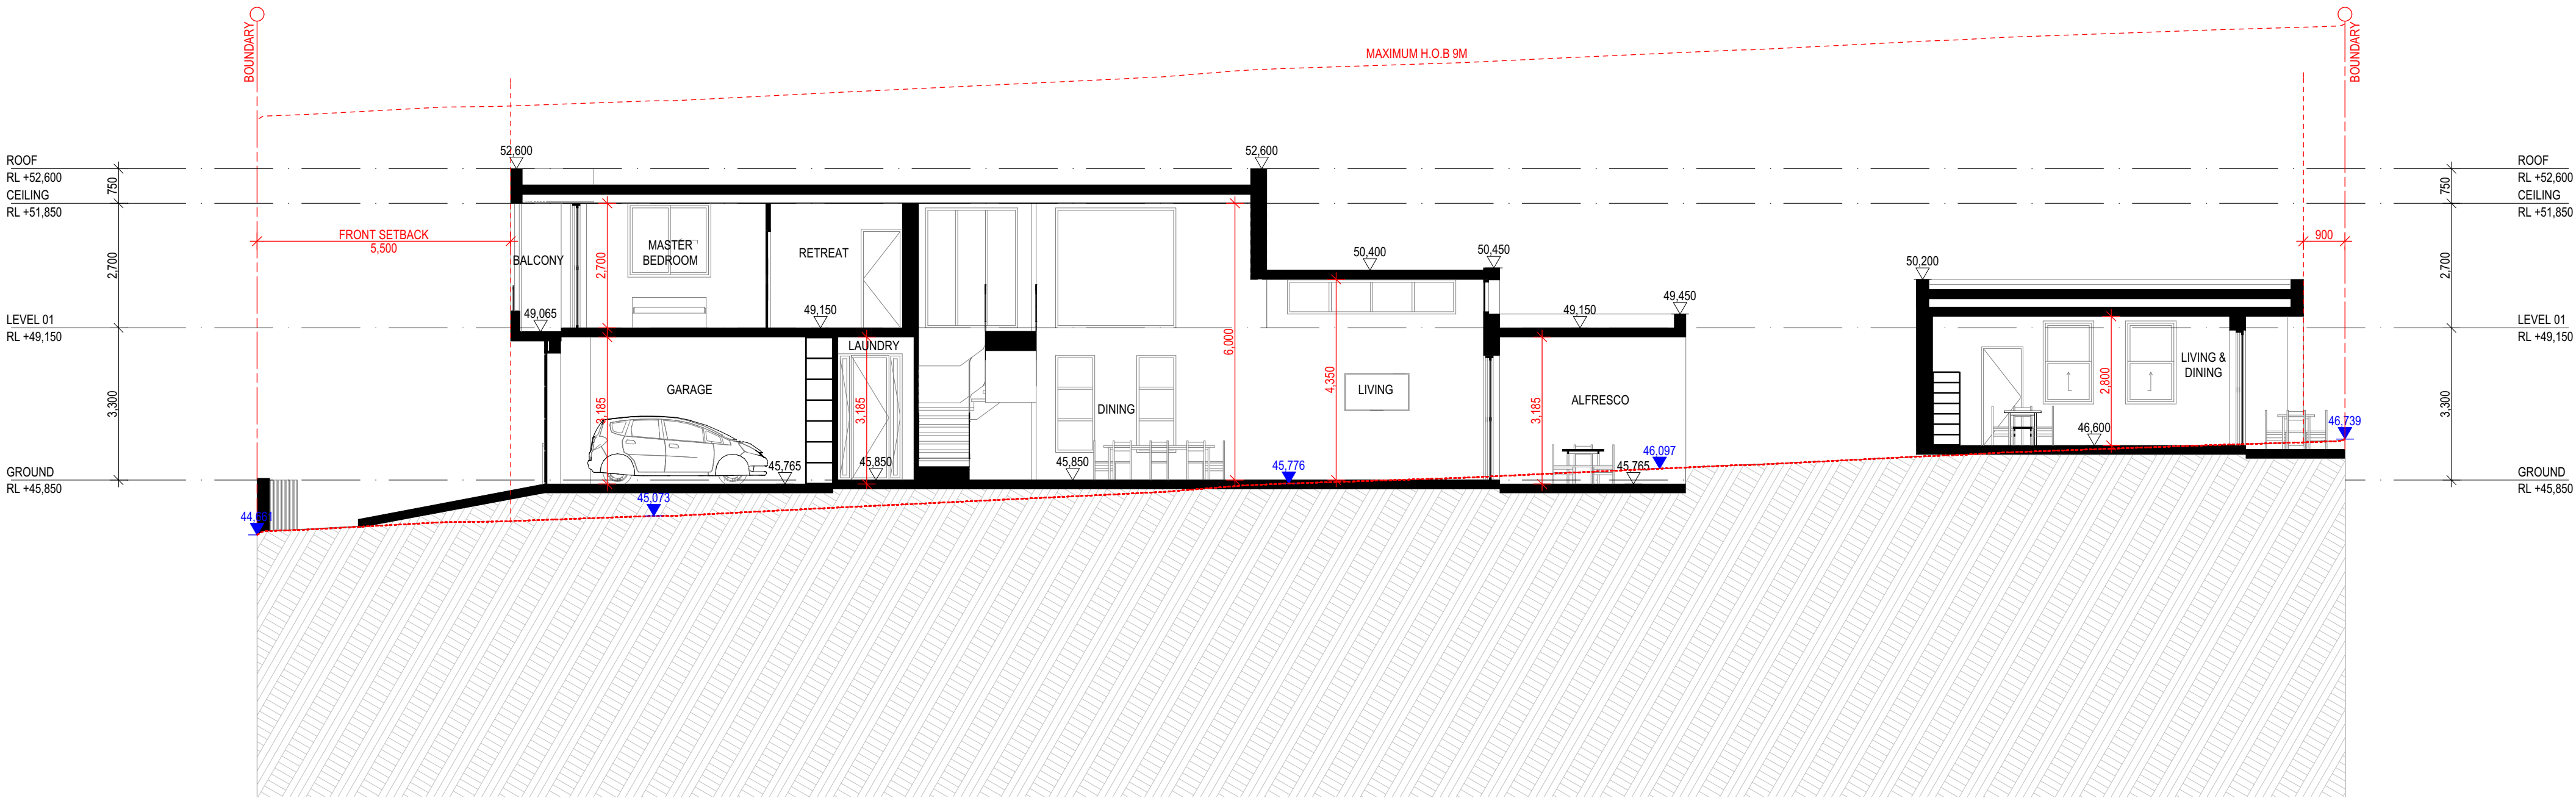

B SECTION

SCALE 1:100



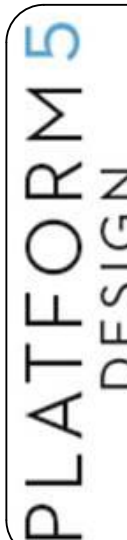

16 RAILWAY PARADE, BURWOOD, NSW, SYDNEY - 2134-
EMAIL: INFO@PLATFORMFIVE.COM.AU
WEBSITE: WWW.PLATFORMFIVE.COM.AU

PROJECT TITLE

21 EDGAR STREET, YAGOONA - NSW - 2199

CLIENT

VISCONA DEVELOPMENT GROUP PTY LTD

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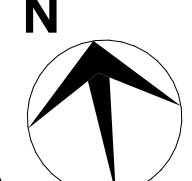
DRAWING TITLE:
SECTIONS

PROJECT NUMBER:
22-025

DRAWING NUMBER: **DA4001**

DATE OF ISSUE
30/07/2022

C

N


SCALE: **AS SHOWN**

DEVELOPMENT APPLICATION



000792410028 Jul 2022

AssessorShafee Hassan

Accreditation No. DMN/19/1938

Address

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YAGOONA , NSW , 2199



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000792409028 Jul 2022

AssessorShafee Hassan

Accreditation No. DMN/19/1938

Address

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YAGOONA , NSW , 2199



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- 110MM STUD WALL
- 200MM BLOCK WALL CONSTRUCTION


EX XXXX EXISTING NATURAL GROUND LEVELS

30 SET DOWN IN BATHROOMS


XXXX SSL - STRUCTURAL SLAB LEVEL

EXISTING STRUCTURES TO BE DEMOLISHED.


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 - Drainage to be in accordance with part 3 of the BCA, point of discharge to meet local authority requirement

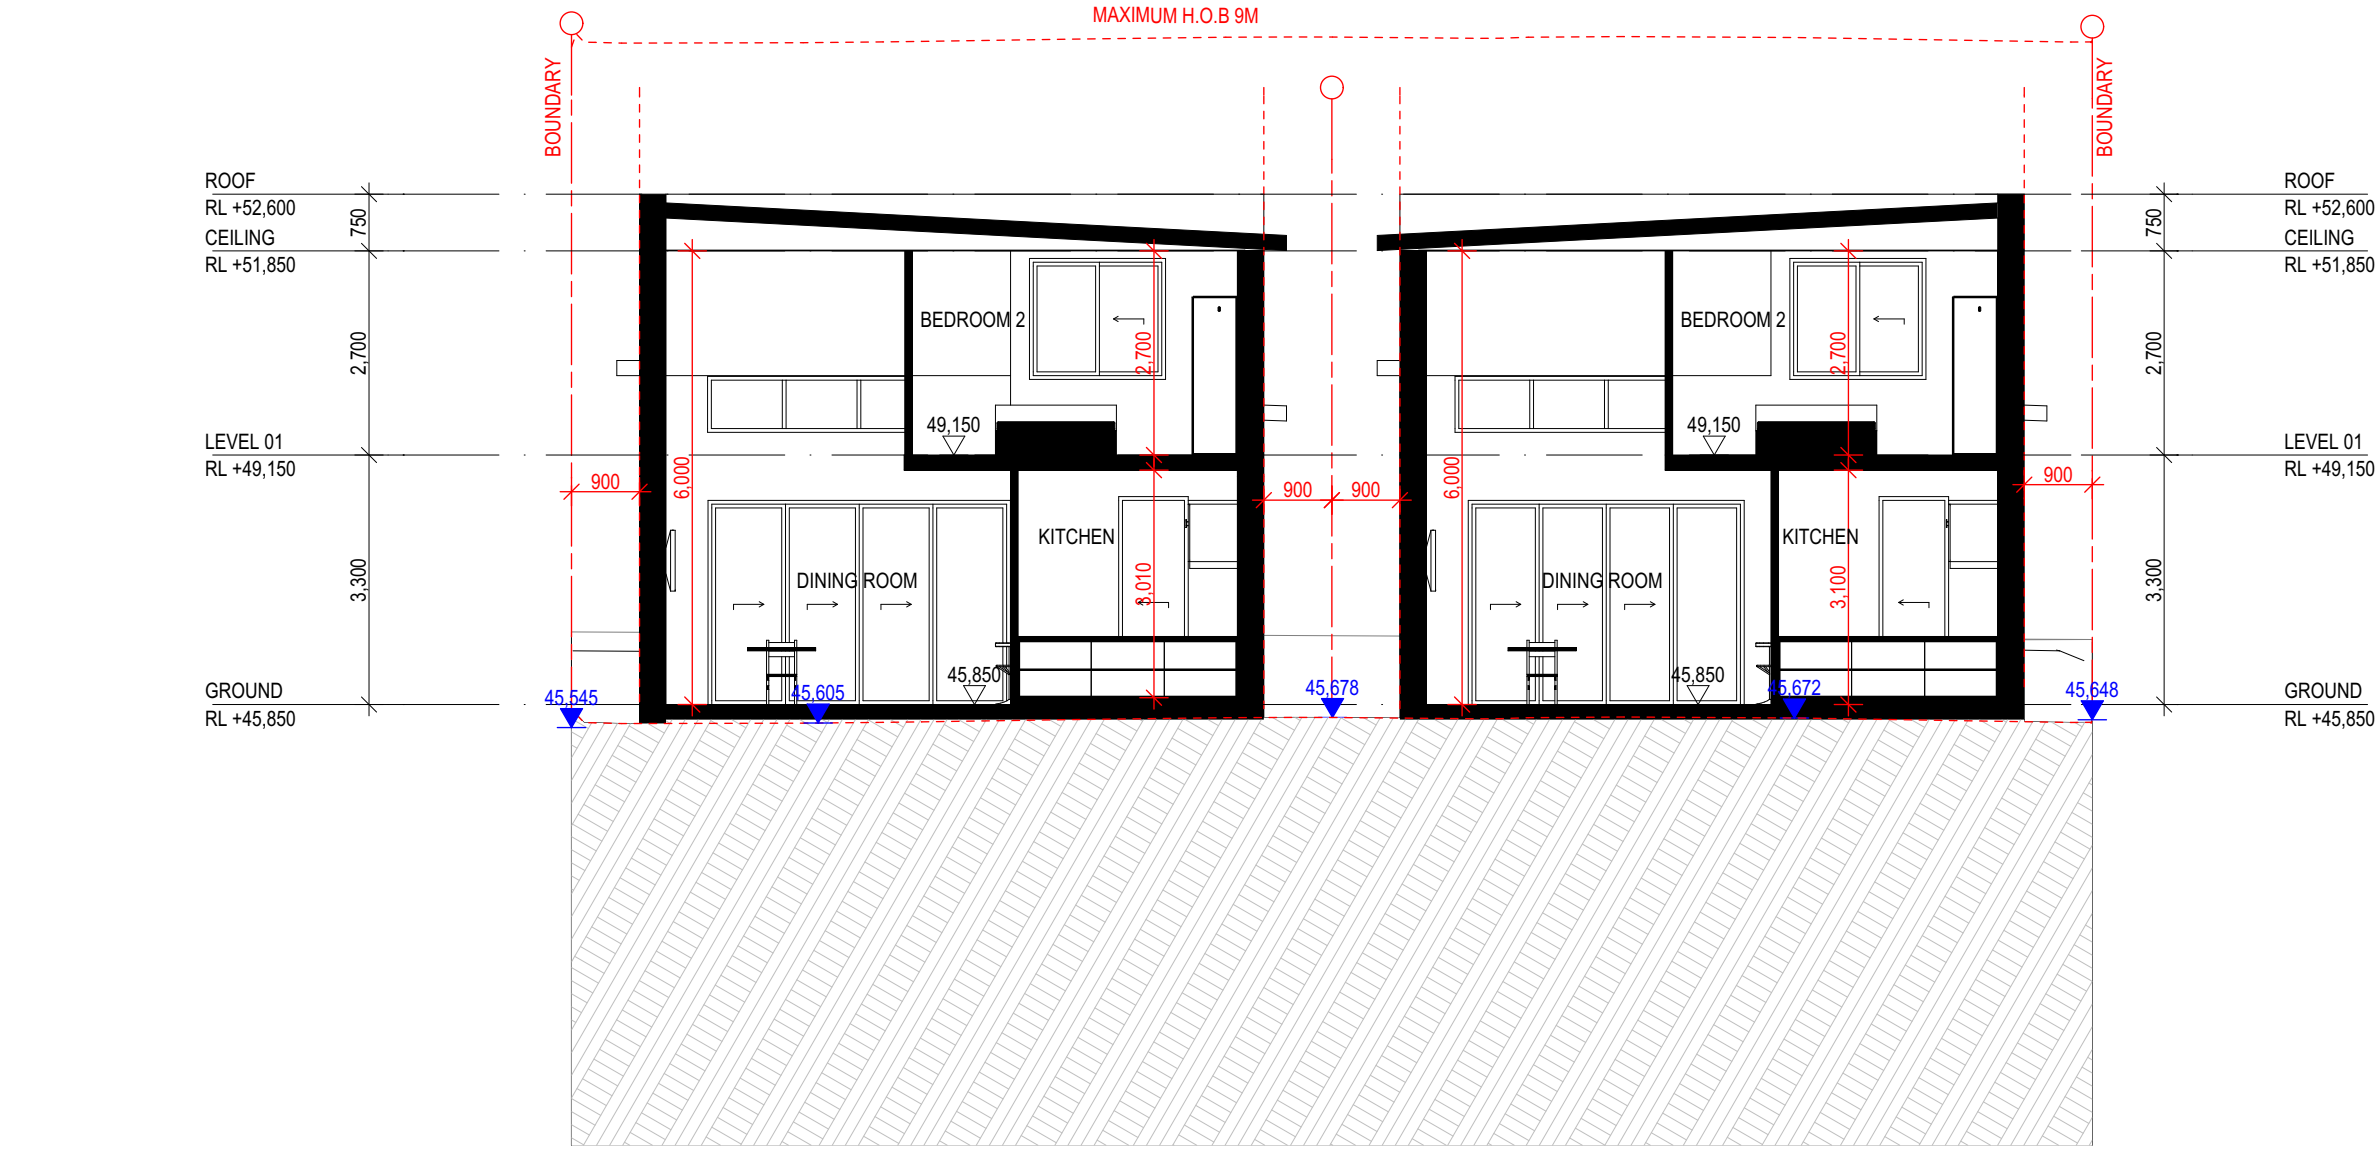

C SECTION
SCALE 1:100

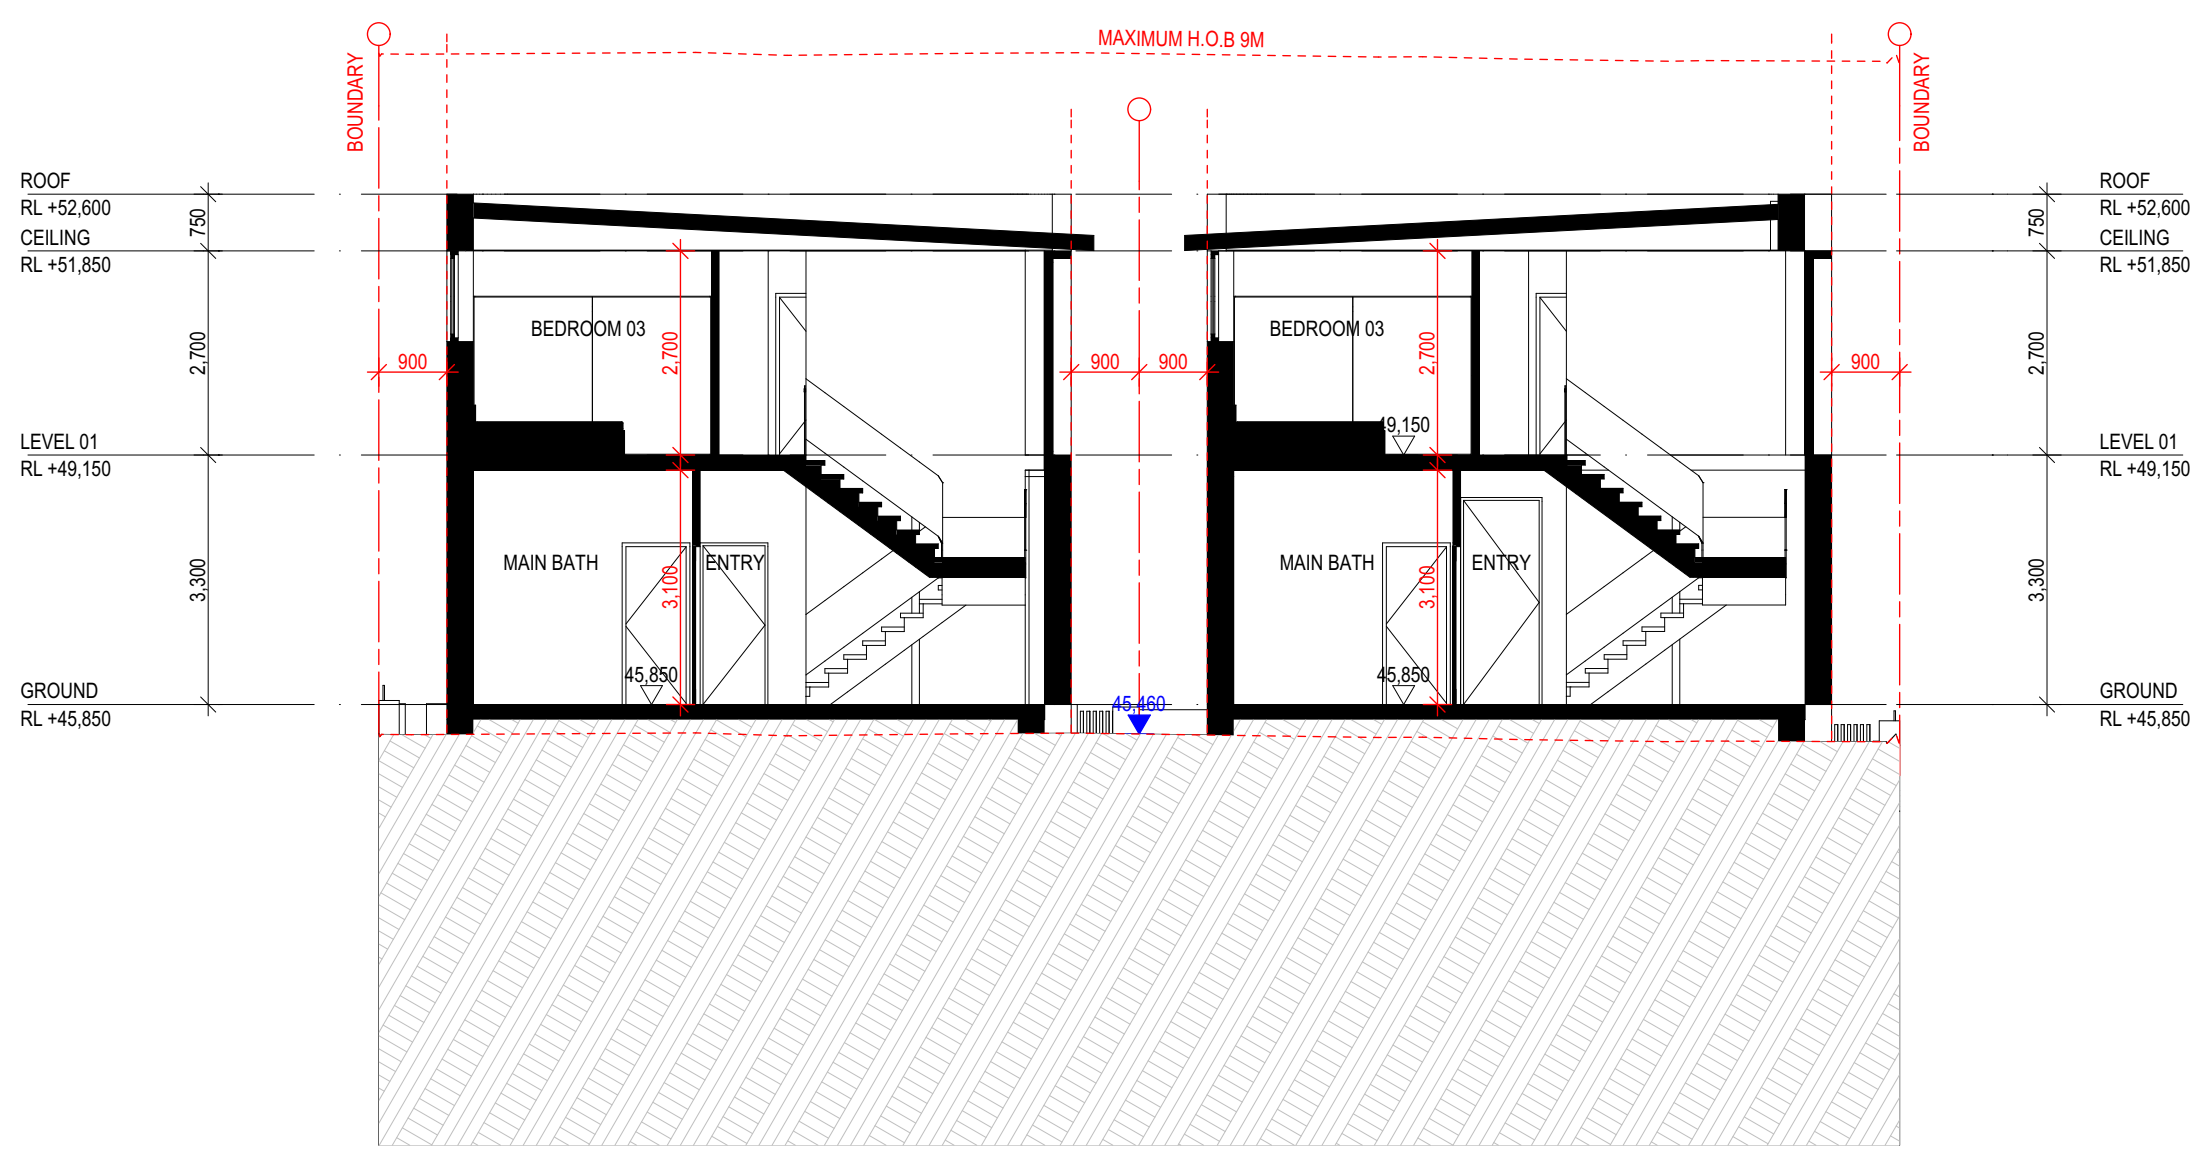


D SECTION
SCALE 1:100

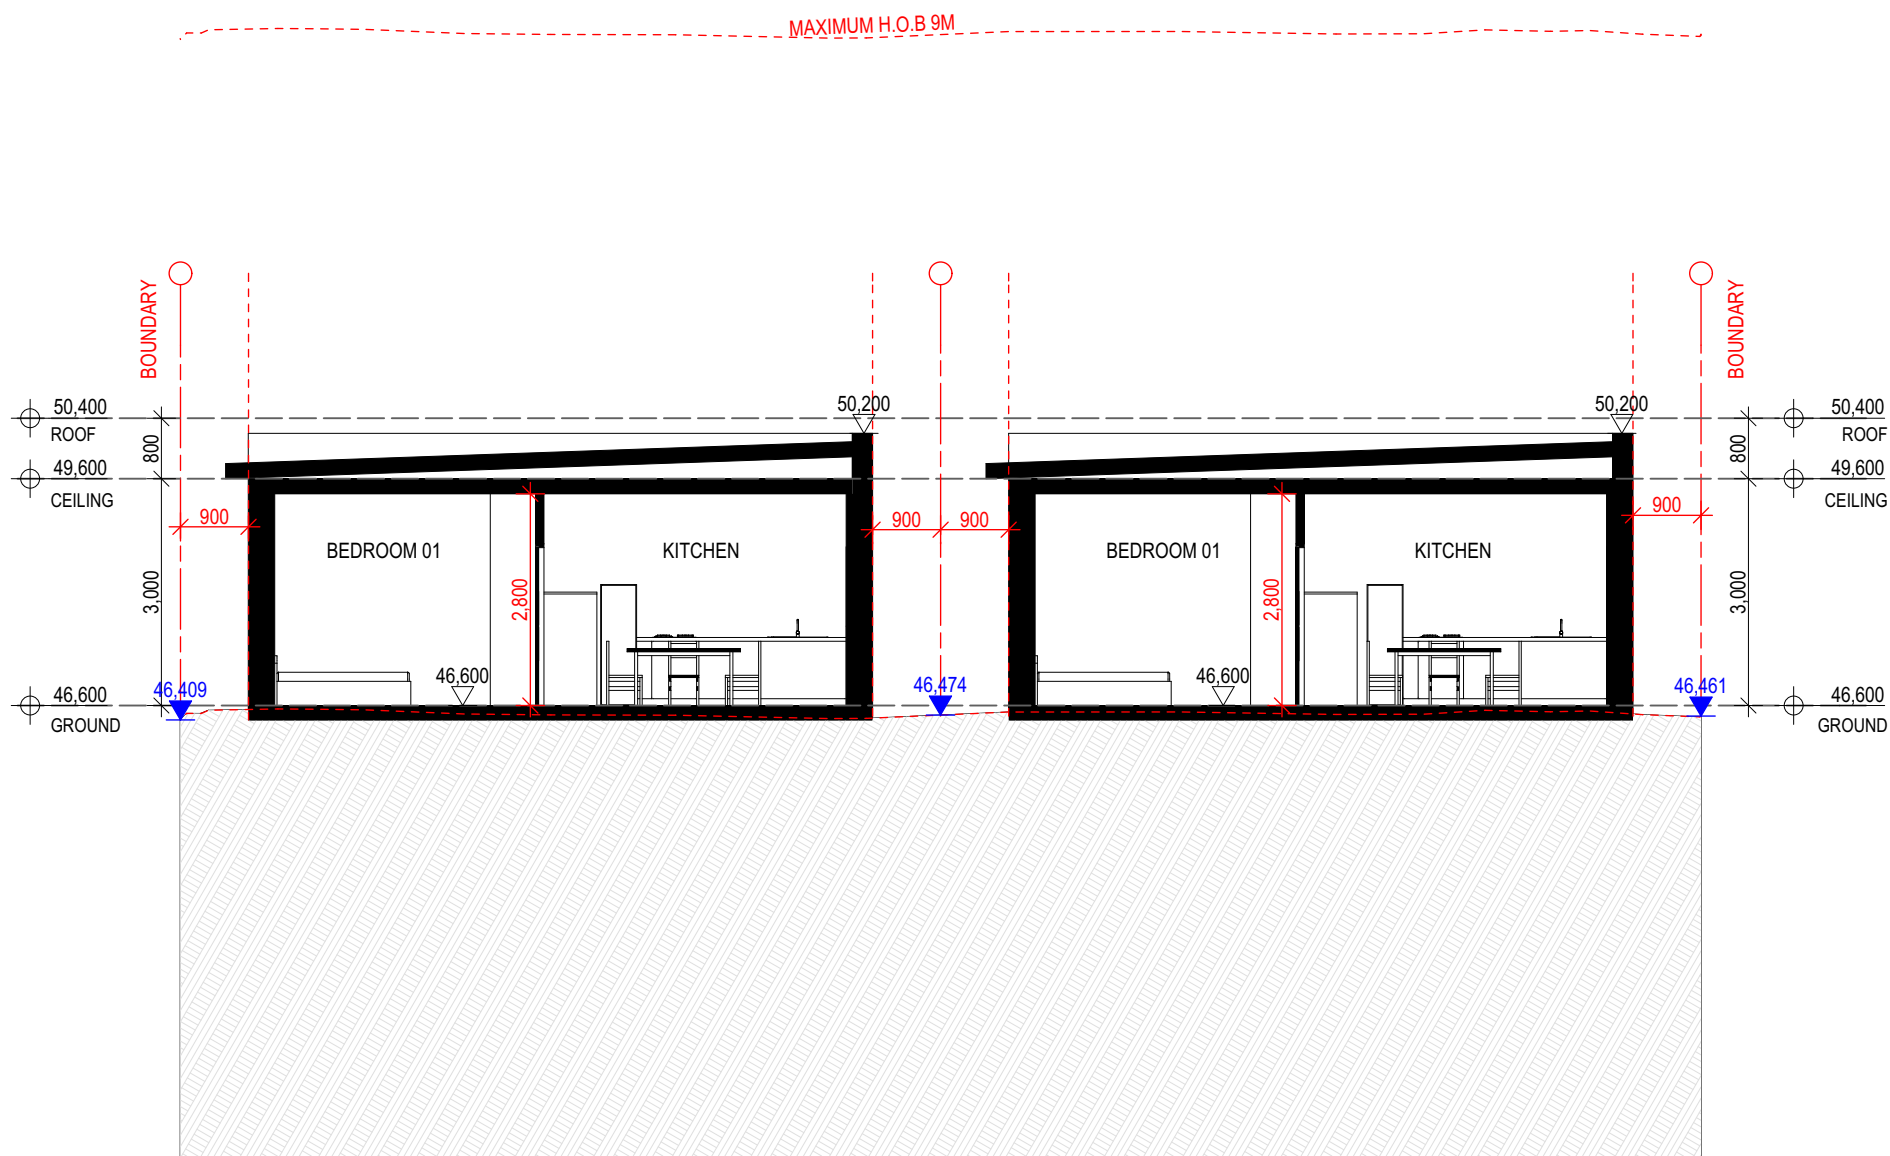

E SECTION
SCALE 1:100

PLATFORM 5
DESIGN

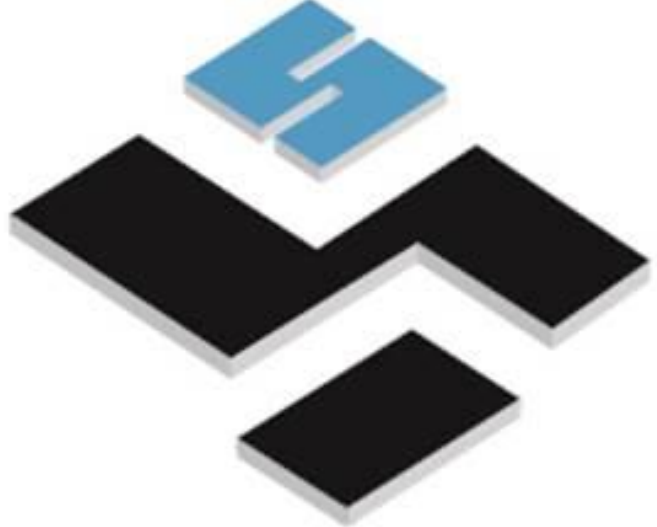

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WEBSITE: WWW.PLATFORMFIVE.COM.AU

PROJECT TITLE
21 EDGAR STREET, YAGOONA - NSW - 2199

CLIENT
VISCONA DEVELOPMENT GROUP PTY LTD

REV	DESCRIPTION	DATE
A	ISSUE FOR INFORMATION	14/06/2022
B	ISSUE FOR CONSULTANTS	15/06/2022
C	ISSUE FOR DA SUBMISSION	30/07/2022

DRAWING TITLE:
SECTIONS

PROJECT NUMBER:
22-025

DRAWING NUMBER: **DA4002**

DATE OF ISSUE
30/07/2022

C

N

SCALE: **AS SHOWN**

DEVELOPMENT APPLICATION

LEGEND

	200MM DINCEL WALL
	250MM BRICK VENEER CONSTRUCTION
	270MM DOUBLE BRICK CONSTRUCTION
	110MM SINGLE BRICK CONSTRUCTION
	110MM STUD WALL
	200MM BLOCK WALL CONSTRUCTION

EX XXXX EXISTING NATURAL GROUND LEVELS

30 SET DOWN IN BATHROOMS

XXXX SSL - STRUCTURAL SLAB LEVEL

--- EXISTING STRUCTURES TO BE DEMOLISHED.


GENERAL NOTES:

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6. Articulation joints in masonry to be provided as per Engineers Details and/or in accordance with BCA clause 3.3.1.8
7. Retaining walls are required to be engineer designed and certified where required
8. All plumbing works to be strictly in accordance with A.S. 3500 and approved by relevant authorities
9. All drawings are to be read in conjunction with the Engineer's Structural Drawings
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11. Batters to comply with appropriate soil classification described in Table 3.1.1.1 BCA Vol 2
12. Engineer to provide design to address footings if built in close proximity to sewer, stormwater easements
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16. Provide cold water connection & go to dishwasher space
17. Hotwater system to comply with A.S.3500
18. Downpipes to be a maximum 12m spacing and adjacent to valley intersections
19. Drainage to be in accordance with part 3 of the BCA, point of discharge to meet local authority requirement



BORAL RVIERSIDE-
SANDY BAY OR SIMILAR

A

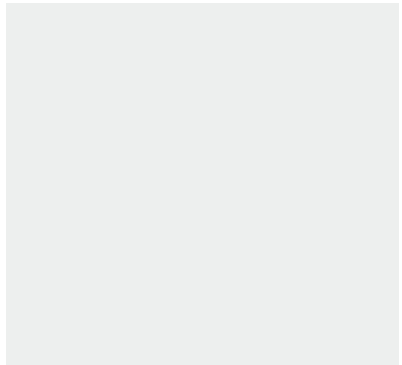

RENDER & PAINT FINISH
DULUX- LEXICON WHITE

B



AUSTRAL BRICK -
BOWRAL BLUE
OR SIMILAR

C




ALUMINIUM FRAMED
WINDOWS & DOORS
MONUMENT GREY
OR
DULEX POWDERCOAT
DARK NIGHT OR
SIMILAR

D




DECO CLAD NARROW
LINE RANGE-
NATURAL CHESTNUT
OR SIMILAR

E

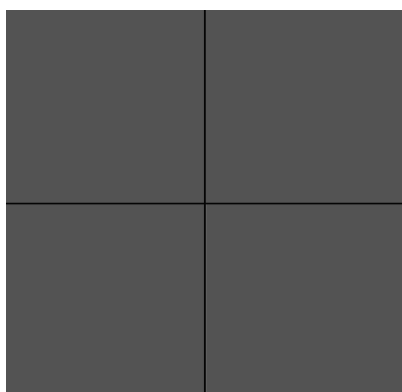

FINISHED STENCILLED
CONCRETE OR SIMILAR

F

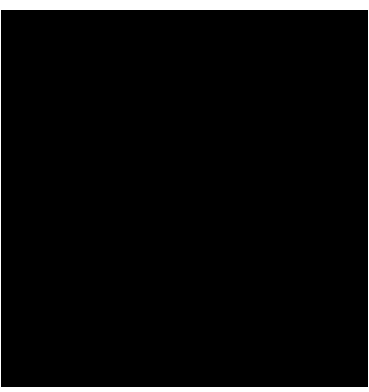


RENDER & PAINT FINISH
DULUX- DARK NIGHT

G



COLOURS ARE INDICITATIVE ONLY AND MAY VARY DUE TO AVAILABILITY

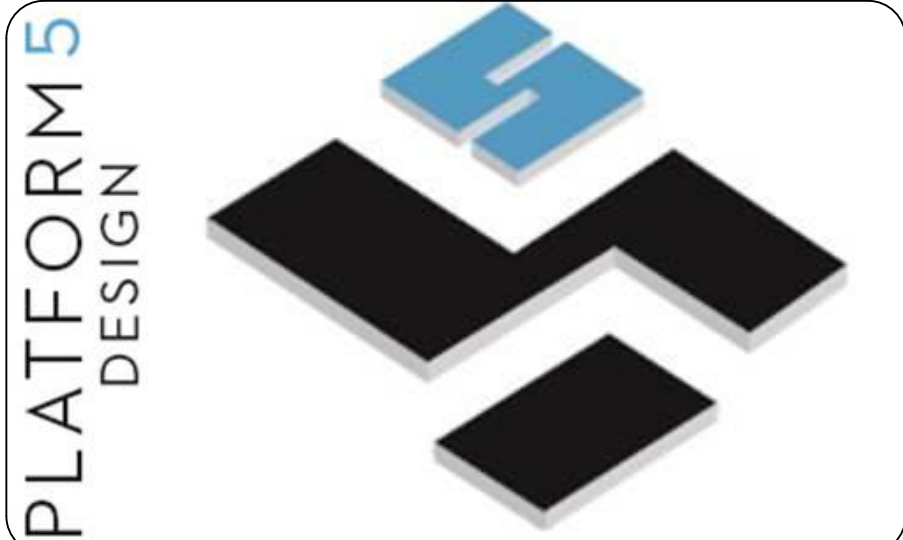

16 RAILWAY PARADE, BURWOOD, NSW, SYDNEY - 2134-

EMAIL: INFO@PLATFORMFIVE.COM.AU

WEBSITE: WWW.PLATFORMFIVE.COM.AU

PROJECT TITLE

21 EDGAR STREET, YAGOONA - NSW - 2199

CLIENT

VISCONA DEVELOPMENT GROUP PTY LTD

REV	DESCRIPTION	DATE
A	ISSUE FOR INFORMATION	14/06/2022
B	ISSUE FOR CONSULTANTS	15/06/2022
C	ISSUE FOR DA SUBMISSION	30/07/2022

DRAWING TITLE: FINISHES SCHEDULE	PROJECT NUMBER: 22-025
--	----------------------------------

DRAWING NUMBER: **DA6301**


DATE OF ISSUE: **30/07/2022**

SCALE: **AS SHOWN**

DEVELOPMENT APPLICATION

C


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
WINDOW SCHEDULE					
ID	WINDOW TYPE	WIDTH	HEIGHT	SILL HEIGHT	QUANTI..
W01	FIXED WINDOW	3,000	800	1,800	4
W02	SLIDING WINDOW	2,000	1,500	1,200	2
W03	AWNING WINDOW	1,090	1,800	900	2
W04	AWNING WINDOW	1,100	1,800	900	4
W05	AWNING WINDOW	900	1,800	900	2
W06	SLIDING WINDOW	2,800	670	930	2
W07	SLIDING WINDOW	2,200	670	930	2
W08	SLIDING WINDOW	1,500	900	1,800	4
W09	AWNING WINDOW	1,200	1,800	900	2
W10	AWNING WINDOW	850	2,100	600	4
W11	AWNING WINDOW	900	900	1,800	2
W12	AWNING WINDOW	1,000	1,700	1,000	2
W13	AWNING WINDOW	900	2,700	0	2
W14	AWNING WINDOW	1,100	900	1,800	2
W15	FIXED WINDOW	2,000	2,600	0	2
W16	FIXED WINDOW	2,610	2,600	0	2
W17	FIXED WINDOW	3,650	740	300	2
W18	FIXED WINDOW	4,000	740	300	2
W19	FIXED WINDOW	1,800	1,600	1,000	2
W20	SLIDING WINDOW	1,800	1,200	1,500	4
W21	SLIDING WINDOW	1,800	1,600	1,100	2
					52

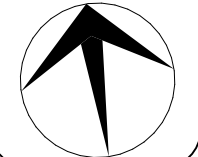DOOR SCHEDULE				
ID	Door Type	Width	Height	Quantity
D01	GARAGE DOOR	5,050	2,835	2
D02	HINGED DOOR	820	2,700	2
D03	HINGED DOOR	820	2,100	29
D04	HINGED DOOR	1,000	2,700	1
D05	POCKET DOOR	820	2,700	2
D06	HINGED DOOR	2,400	2,700	1
D07	HINGED DOOR	3,650	2,700	1
D08	HINGED DOOR	2,000	2,500	1
D09	HINGED DOOR	4,000	2,700	1
D10	SLIDING DOOR	3,400	2,500	2
D12	SLIDING DOOR	3,050	2,700	2


LEGEND




200MM DINCEL WALL




250MM BRICK VENEER CONSTRUCTION




270MM DOUBLE BRICK CONSTRUCTION




110MM SINGLE BRICK CONSTRUCTION




110MM STUD WALL




200MM BLOCK WALL CONSTRUCTION




EXISTING NATURAL GROUND LEVELS



SET DOWN IN BATHROOMS

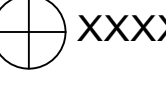

SSL - STRUCTURAL SLAB LEVEL



EXISTING STRUCTURES TO BE DEMOLISHED.

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PLATFORM 5
DESIGN



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DRAWING TITLE:
WINDOW & DOOR SCHEDULE

PROJECT NUMBER:
22-025

DRAWING NUMBER: DA6302

DATE OF ISSUE 30/07/2022

C

N

SCALE: AS SHOWN

DEVELOPMENT APPLICATION